OWNER

PONMATTAM FAM REAL ESTATE TR PONMATTAM, VARGHESE P TRSTEE

ARCHITECT

JOSEPH KALLER

AA#26001212 2417 Hollywood Blvd. Hollywood Florida 33020 954.920.5746 joseph@kallerarchitects.com

www.kallerarchitects.com

FILLMORE STREET APARTMENTS

2215 FILLMORE ST. HOLLYWOOD, FL 33020

2215 FILLMORE ST. HOLLYWOOD, FL 33020

Lot Area - Public Records:

Legal Description:

Existing Building Use: Single Family Residential Existing Land Use: Residential County Future Land Use: Regional Activity Center

Allowed Use(s) - Primary: Residential(2), Lodging(1), Office(1),

FEMA Flood Zone: 12.0' Flood Elevation (Feet NAVD88)

PROPOSED BUILDING INTENSITY Maximum Building Height: Maximum Height - Stories: 1.75(35,878 SF) 34,644 ft² Floor Area Ratio: 23% Minimum Open Space:

TECHNICAL ADVISORY COMMITEE MEETING AGENDA

PRELIMINARY SITE PLAN REVIEW MARCH 6, 2023

HOLLYWOOD LITTLE RANCHES

1-26 B LOT 2 BLK 10


BASIC ZONING

Municipal Future Land Use: Regional Activity Center (RAC)

ADDITIONAL ZONES

Estimated Residential Units: 27 UNITS Unlimited



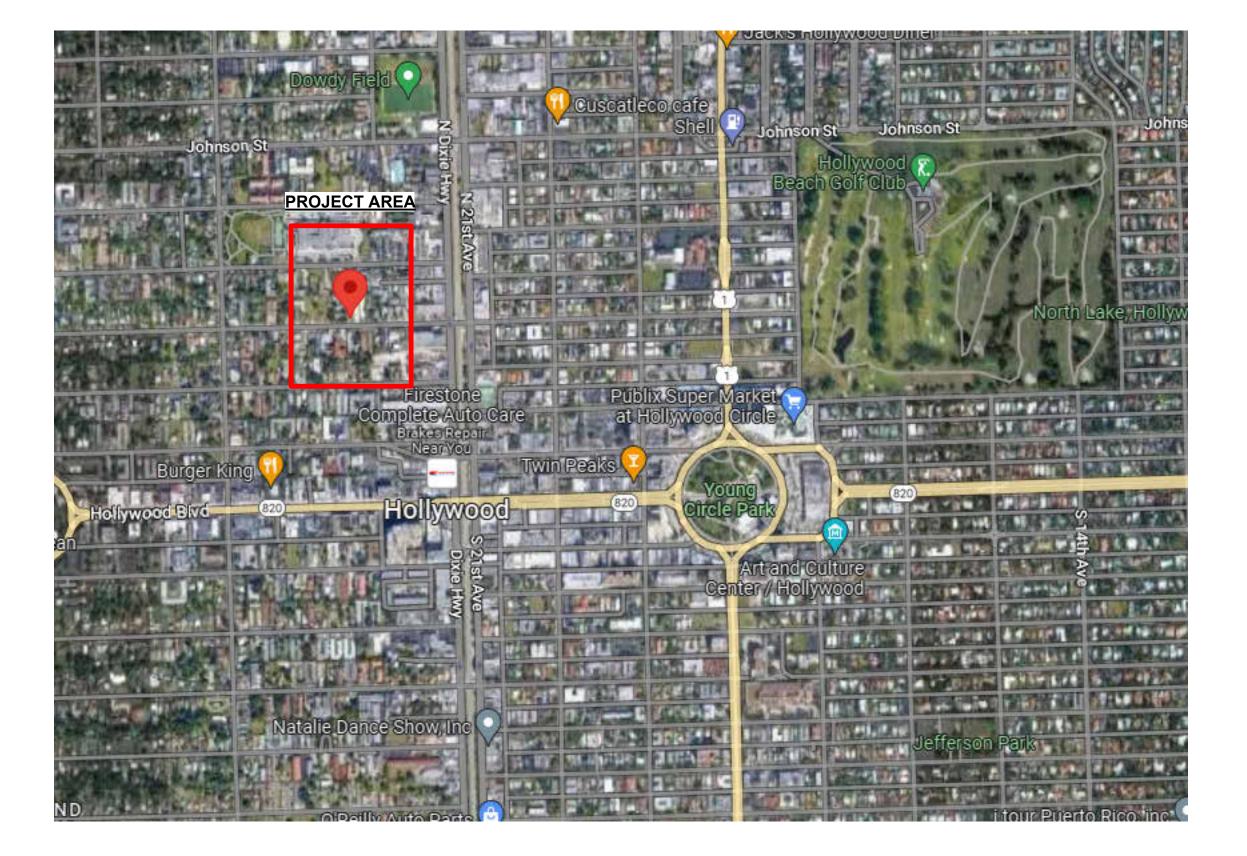





DESCRIPTION:

LOT 2, BLOCK 10, "AN AMENDED PLAT OF HOLLYWOOD LITTLE RANCHES.", ACCORDING TO PLAT THEREOF AS RECORDED IN PLAT BOOK 1, PAGE 26, OF THE PUBLIC RECORDS OF BROWARD COUNTY, FLORIDA. SAID LAND SITUATED IN THE CITY OF HOLLYWOOD, BROWARD COUNTY, FLORIDA

SURVEYOR NOTES:

- 1). THE LAND DESCRIPTION SHOWN HEREON WAS PROVIDED BY THE CLIENT. EASEMENTS AND RIGHTS-OF-WAY PER RECORD PLAT HAVE BEEN SHOWN HEREON. NO FURTHER SEARCH FOR MATTERS OF RECORD HAS BEEN MADE BY THIS FIRM.
- 2). THE BOUNDARY SURVEY OF THE REAL PROPERTY DEPICTED ON THIS SURVEY REPRESENTS THE PROFESSIONAL OPINION OF THE UNDERSIGNED, BASED ON THE DESCRIPTION ATTACHED HEREON.
- 3.) THE USE OF THE WORD "CERTIFY" AS USED HEREON IS AN EXPRESSION OF PROFESSIONAL OPINION AND DOES NOT CONSITUTE A WARRANTY OR GUARANTEE,
- 4.) THIS SURVEY IS NOT VALID WITHOUT THE SIGNATURE AND ORIGINAL SEAL OF A FLORIDA LICENSED PROFESSIONAL SURVEYOR AND MAPPER.
- 5.) BENCHMARK REFERENCE NATIONAL GEODETIC SURVEY DESIGNATION M 312, PID - AD2500, ELEVATION = 13.44
- 6.) ELEVATIONS SHOWN ARE REFERENCED TO NORTH AMERICAN VERTICAL DATUM OF
- 7.) THIS SURVEY REFLECTS OBSERVED EVIDENCE OF UTILITIES. LACKING EXCAVATION, THE **EXACT LOCATION OF UNDERGROUND FEATURES CANNOT BE ACCURATELY AND** COMPLETELY DEPICTED.
- 8). THIS SURVEY IS PREPARED FOR THE SOLE AND EXCLUSIVE USE OF THE PARTIES AS SURVEYED FOR AND AS CERTIFIED TO AND SHALL NOT BE RELIED UPON BY ANY OTHER ENTITY OR INDIVIDUAL.
- 9.)NORTH ARROW RELATIVE TO ASSUMED EAST ALONG THE CENTERLINE OF FILMORE
- 10.) ADDITIONS OR DELETIONS TO SURVEY MAPS OR REPORTS BY OTHER THAN THE SIGNING PARTY IS PROHIBITED WITHOUT WRITTEN CONSENT OF THE SIGNING PARTY. 11.)WATER SERVICE MAIN LOCATED NEAR REAR PROPERTY LINE UNABLE TO FIELD LOCATE UNKNOWN SIZE. CALL FOR LOCATES BEFORE DIGGING.
- 12.)UNRECORDED EASEMENTS OBSERVED ON THE NORTH PROPERTY LINE: OVERHEAD UTILITIES, WATER METERS AND WEST PROPERTY LINE, OVERHEAD UTILITY.

SUMMARY TABLE OF TITLE EXCEPTIONS

DATED: January 31,2023 ORT FILE NUMBER 23005784

DESCRIPTION EXCEPTIONS 1-7) STANDARD EXCEPTIONS

8.) Plat matters Hollywood Little Ranches, Plat Book 1, Pg. 26. B.C.R.

Shown on Survey

9.) Right-of-Way Map in Plat Book 8, Pg. 14

Does not affect this property

10.) Development Ordinance ORB 8136/244 Street Name Ordinance

Affects "Filmore Street"

11.) Utility Easements ORB 40244/1465 and 38247/425

12.)Ordinance No. 2002-61 ORB 34145/1891

13.)Rights of Lessees under unrecorded leases

Does not affect this property **Updated Wetlands Map**

COMMENTS

Does not affect this property Does not affect this property

- FURNISHED BY OLD REPUBLIC NATIONAL TITLE INSURANCE COMPANY
- PROVIDED FOR: ATTORNEYS TITLE PARTNERS
- AGENT'S FILE#: 2215 FILMORE STREET TSR PREPARED DATE: JANUARY 31, 2023 ORT FILE No. 23005784

SURVEY CERTIFICATION:

TITLE SEARCH REPORT


THIS IS TO CERTIFY THAT THIS MAP OR PLAT AND THE SURVEY ON WHICH IT IS BASED WERE MADE IN ACCORDANCE WITH THE 2021 MINIMUM STANDARD DETAIL REQUIREMENTS FOR ALTA / NSPS LAND TITLE SURVEYS, JOINTLY ESTABLISHED AND ADOPTED BY ALTA AND NSPS. EFFECTIVE FEBRUARY 23, 2021

AND INCLUDES ITEMS 1, 2, 3, 4, 8, 11(LIMITED), AND 13 OF TABLE A THEREOF.


THE FIELD WORK WAS COMPLETED ON FEBRUARY 06, 2023

LAND AREA/PROPERTY SIZE: GROSS: 22,500 SQUARE FEET - 0.52 ACRE (TO RIGHT-OF-WAY CENTERLINE) NET: 20,500 SQUARE FEET - 0.47 ACRE

ALTA/NSPS LAND TITLE SURVEY

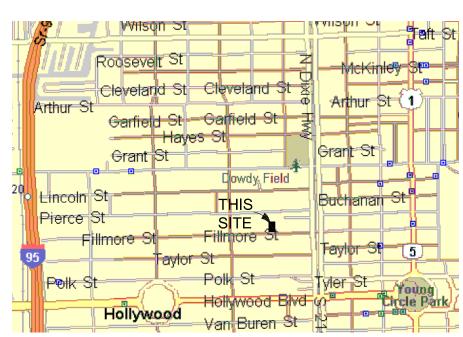


LOCATION MAP NOT TO SCALE

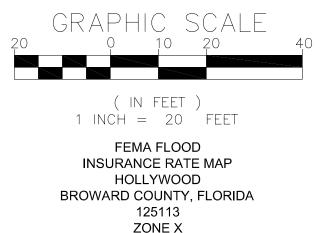

BASE FLOOD ELEVATION=N/A

PANEL No. 12011 C0 569 H FIRM DATE- 08/18/2014

	TREE LEGEND		2
TREE#	TREE SIZE	TREE TYPE	OWNER:
1.	24"	FICUS	∧
2.	18"	BISCHOFIA	
3.	10"	COCONUT PA	λLМ
4.	10"	COCONUT PA	\LM
5.	24"	AVOCADO	
6.	10"	COCONUT PA	\LM
7.	18"	GUMBO LIME	30
8.	8"	OAK	
9.	4"	DEAD	
10.	10"	SABLE PALM	
11.	10"	SABLE PALM	

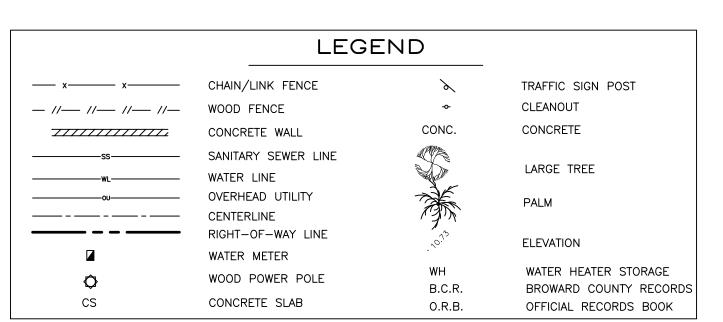


CERTIFIED TO:

REVISION

PONMATTAM FAMILY REAL ESTATE TRUST THIS SURVEY DRAWING WAS PREPARED FOR THE EXCLUSIVE USE OT THE PARTIES AS SURVEYED FOR AND AS CERTIFIED TO, FOR THE EXPRESS PURPOSES STATED HEREON AND/OR CONTAINED IN THE CONTRACT/AGREEMENT WITH THE AFOREMENTIONED CLIENT FOR THIS PROJECT, AND SHALL NOT BE RELIED UPON BY ANY OTHER ENTITY OR INDIVIDUAL. COPYING, DISTRIBUTING OR RE-USE OF THIS SURVEY FOR PURPOSES OTHER THAN WHICH IT WAS INTENDED, WITHOUT WRITTEN PERMISSION WILL BE AT THE RE-USER'S SOLE RISK AND WITHOUT LIABILITY NOTHING SHOWN HEREON SHALL BE CONSTRUED TO GIVE RIGHTS OR BENEFITS TO ANYONE OTHER THAN THOSE CERTIFIED TO.

BY

DATE

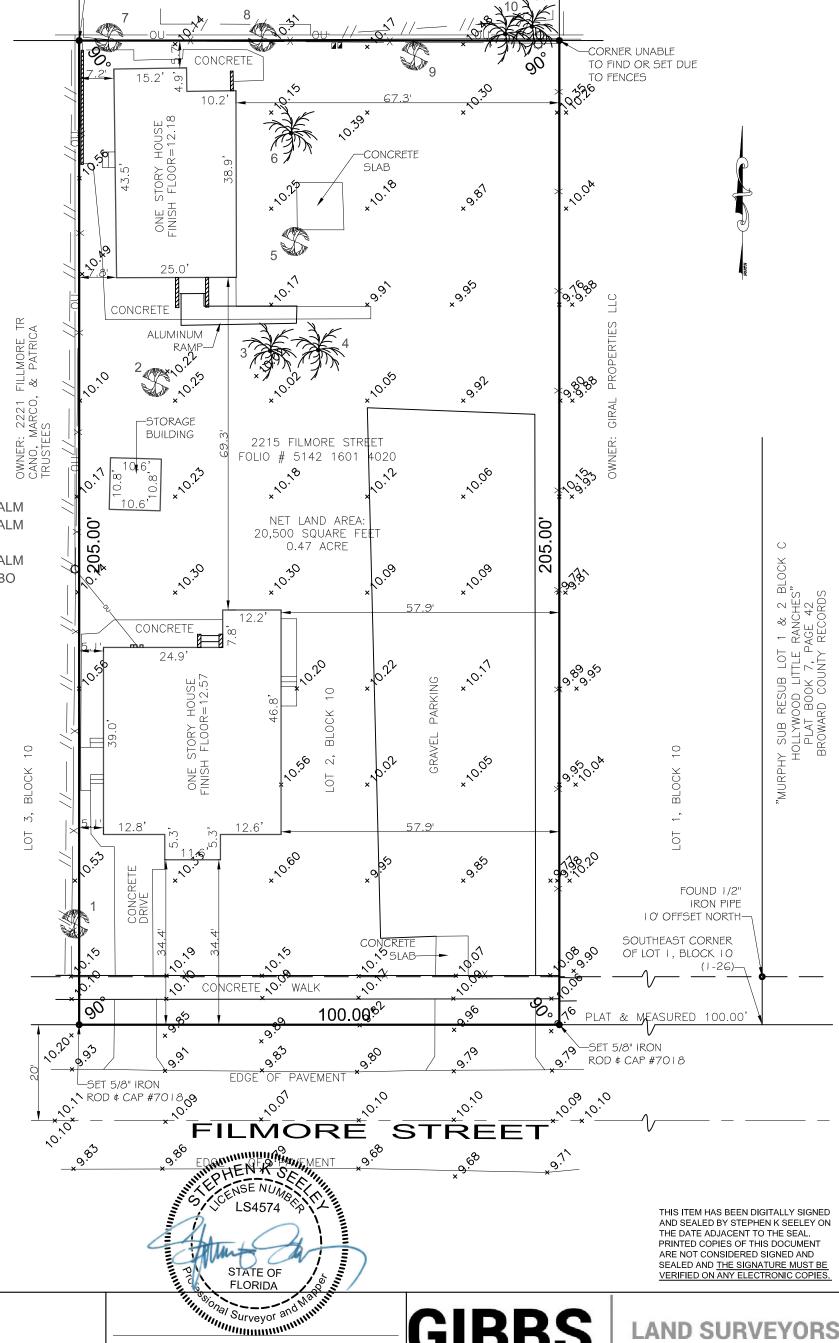

LOT 21, BLOCK 10

TO FIND OR SET DUE

ALTA/NSPS LAND TITLE SURVEY

NOT VALID WITHOUT THE SIGNATURE AND ORIGINAL SEAL OF THE FLORIDA LICENSED SURVEYOR AND MAPPER

JOB #:RN9318 DATE: 02/02/2023 DRAWN BY: CM SCALE: 1"=20' SHEET 1 of 1 CHECKED BY: SKS

STEPHEN K. SEELEY, FOR THE FIRM PROFESSIONAL SURVEYOR & MAPPER FLORIDA REGISTRATION NO. 4574

GIBBS

2131 HOLLYWOOD BOULEVARD, SUITE 204 HOLLYWOOD, FL 33020 (954) 923-7666 LICENSED BUSINESS NO. 7018



Parcel ID: Lot Area - Public Records: Legal Description:

County Future Land Use:

514216014020 20,502 ft² **HOLLYWOOD LITTLE RANCHES** 1-26 B LOT 2 BLK 10

Regional Activity Center

BASIC ZONING Regional Activity Center (RAC) Municipal Future Land Use:

Zone: Single Family Residential Existing Building Use: Existing Land Use: Residential

Minimum Open Space:

N/A FEMA Flood Zone: Future Conditions 100-Year 12.0' Flood Elevation (Feet NAVD88) **ALLOWED PROPOSED BUILDING INTENSITY**

45 ft Maximum Building Height: 45 ft Maximum Height - Stories: Floor Area Ratio: 1.75 34,617 ft² Maximum Built Area:

11'-4" 10'-0" Minimum Side Setback: 22'-10" Minimum Rear Setback:

EXTERNAL LIGHTING

23%

Parking lots, vehicle roadways, pedestrian walkways and building entryways should have "adequate" levels of illumination. The American Crime Prevention Institute

recommends the following levels of external illumination:

-Parking Lots 3-5 foot candles -Walking Surfaces 3 foot candles

-Recreational Areas 2-3 foot candles -Building Entryways 5 foot candles -Maximum 0.5 foot candle level at all property lines ONE BED UNIT 18 66.7% 27 100% TOTAL **UNIT TYPE TOTAL AREA** A/C AREA NON A/C AREA TWO BED UNIT + DEN 1232.14 SF 248.50 SF +/- 1480.64 SF ONE BED UNIT 159.00 SF +/- 947.37 SF 788.37 SF

NOTE:

- ALL CHANGES TO THE DESIGN WILL REQUIRE PLANNING REVIEW AND MAY BE SUBJECT TO BOARD APPROVAL. - ANY LIP 1/4" BUT NOT GREATER THAN 1/2" WILL BE BEVELED TO MEET ADA

REQUIREMENTS. - ALL SIGNAGE SHALL COMPLY WITH THE ZONING AND LAND DEVELOPMENT REGULATIONS

TOTAL:	37 SPACES	42 SPACES

ACCESSIBLE PARKING SPACES	<u>REQUIRED</u>	<u>PROVIDED</u>
	2 SPACES	2 SPACES

(27 UNITS / 5) 5 SPACES

VISITORS

PARKING BREAKDOWN	<u>PROVIDED</u>
REGULAR SPACES:	28 STALLS
TANDEM SPACES:	9 STALLS
VISITOR SPACES:	5 STALLS

TOTAL: 42 SPACES

5 SPACES

Kaller Architecture

2417 Hollywood Blvd. Hollywood Florida 33020 954.920.5746 joseph@kallerarchitects.com



JOSEPH B. KALLER FLORIDA R.A. #0009239


REVISIONS

This drawing, as an instrument of service, is and shall remain the property of the Architect and shall not be reproduced, published or used in any way without the permission of the Architect.

PROJECT No.: SCHIFFINO

SHEET

CHECKED BY:

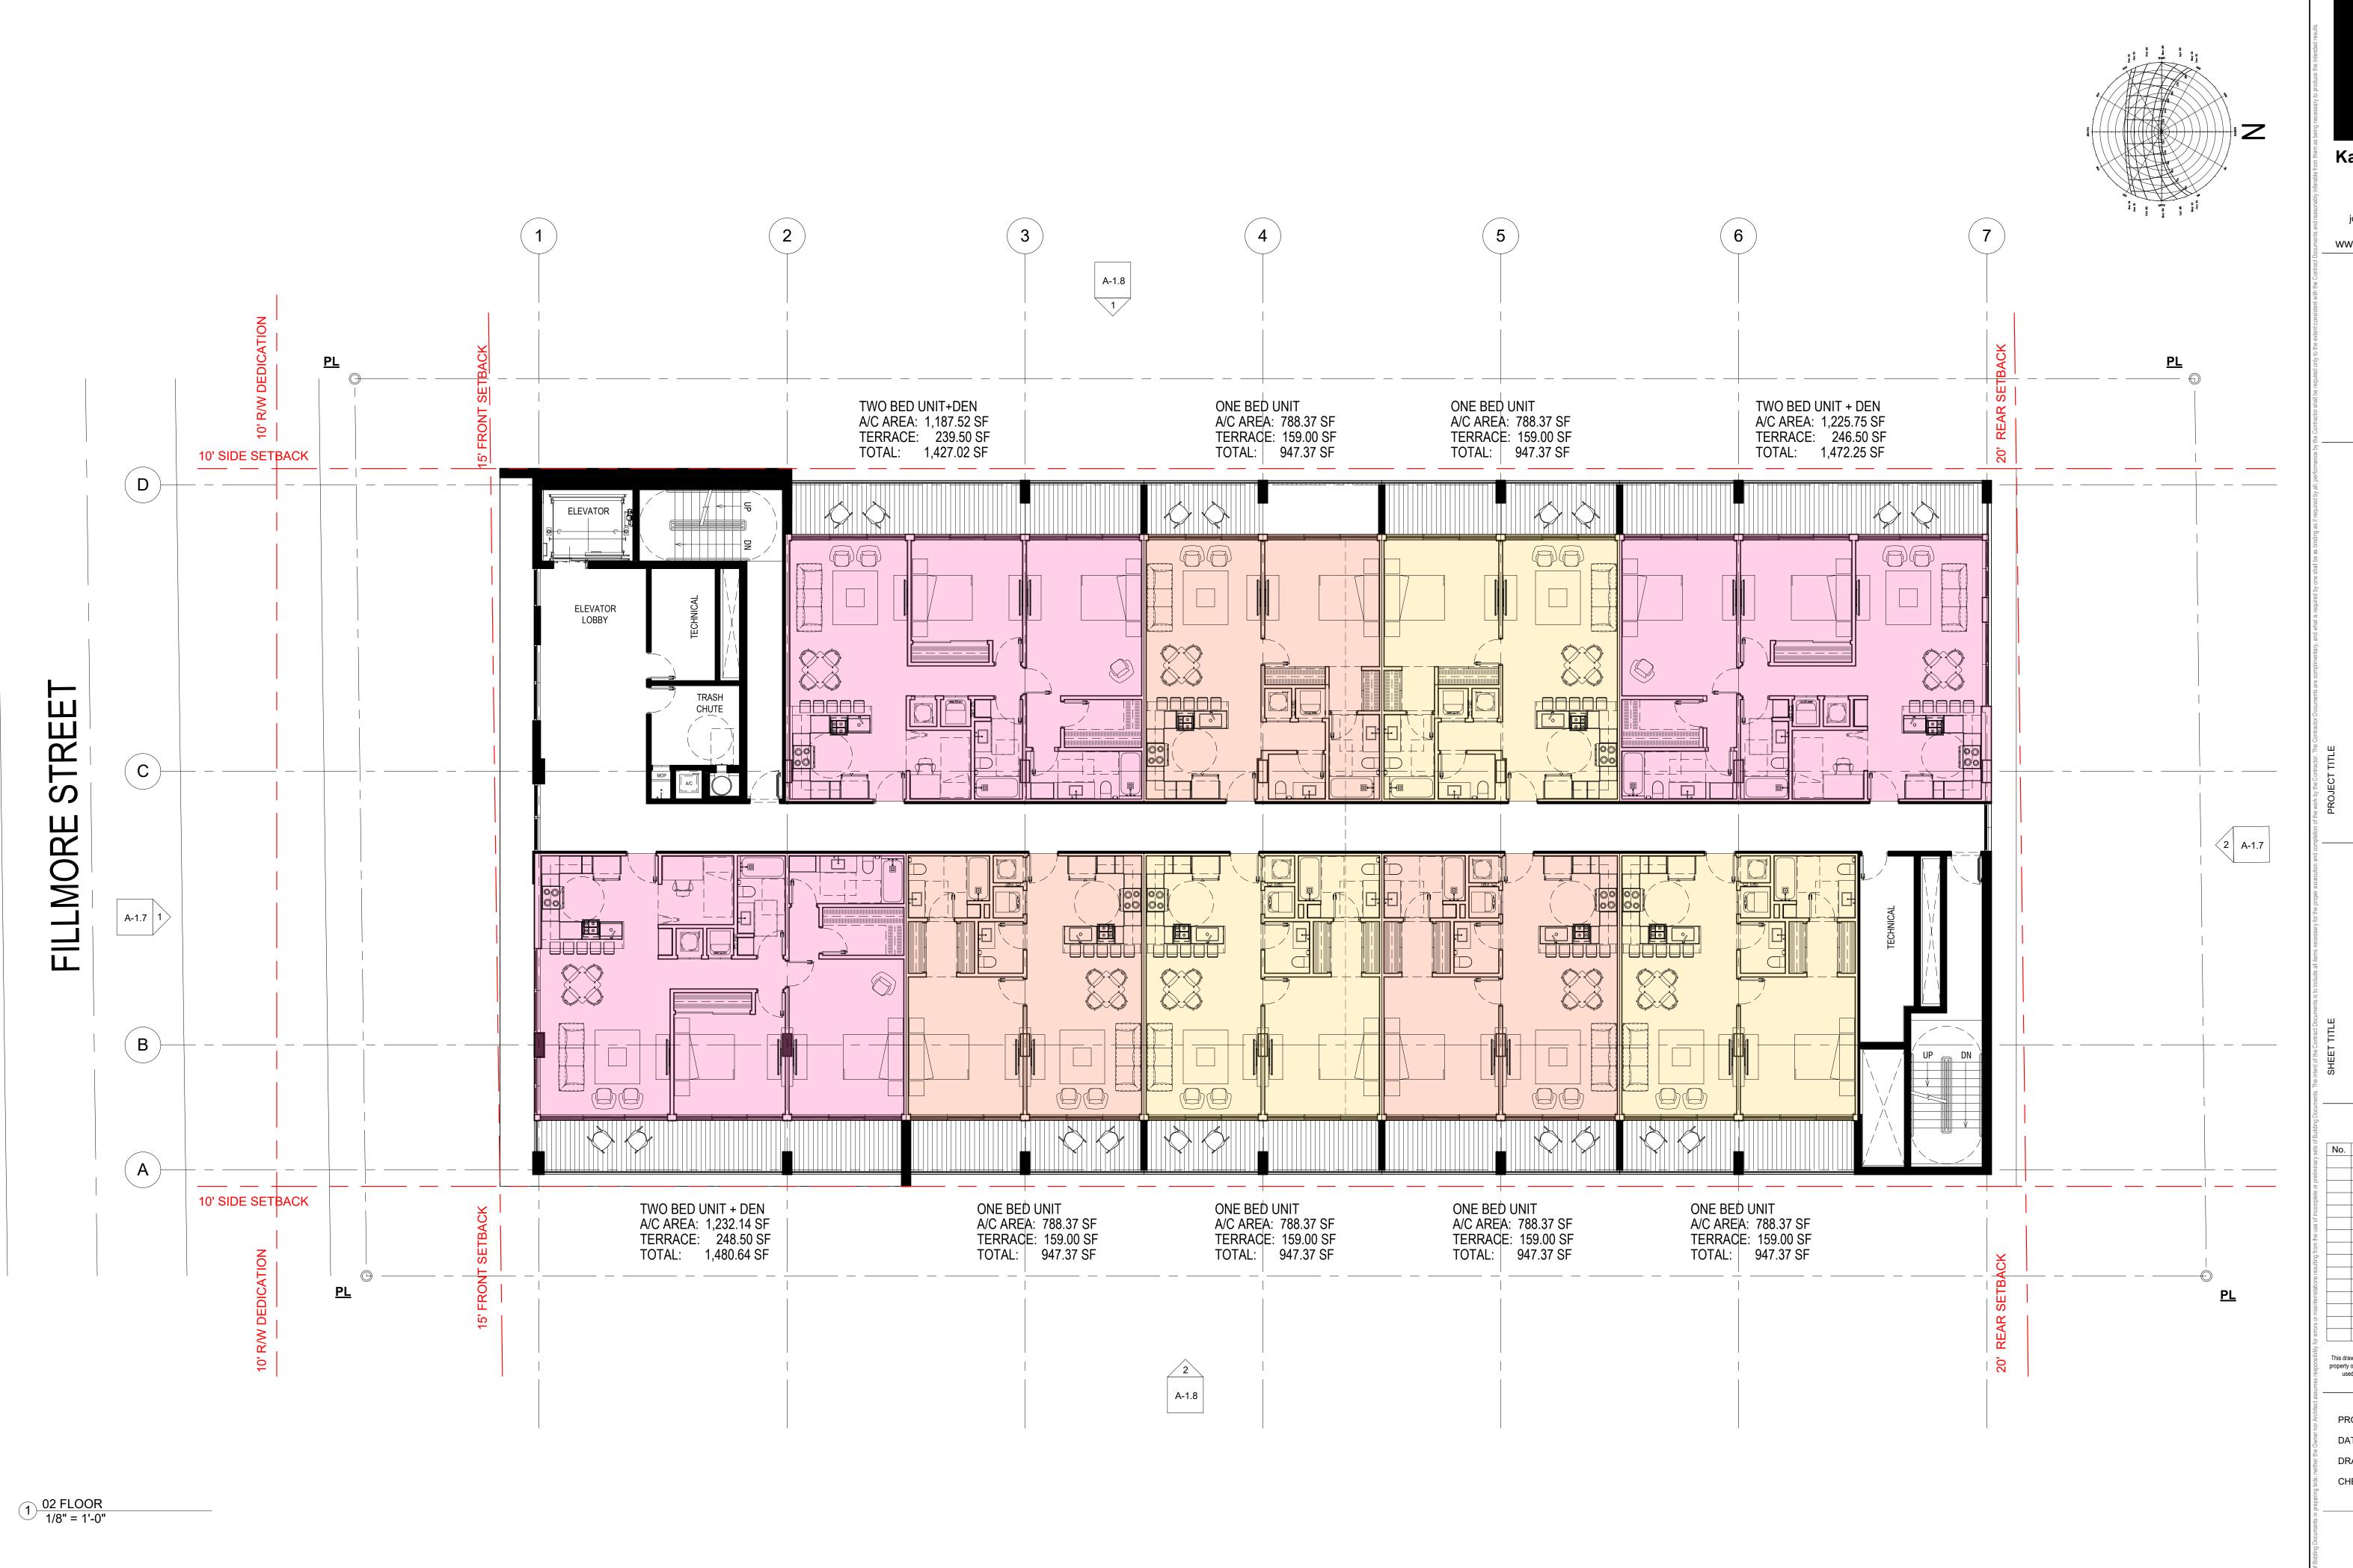

Kaller Architecture AA#26001212 2417 Hollywood Blvd. Hollywood Florida 33020 954.920.5746 joseph@kallerarchitects.com

www.kallerarchitects.com

SEAL

JOSEPH B. KALLER FLORIDA R.A. #0009239


2ND, 3RD, PLANS

REVISIONS

This drawing, as an instrument of service, is and shall remain the property of the Architect and shall not be reproduced, published or used in any way without the permission of the Architect.

PROJECT No.: 22-219 DATE:

DRAWN BY: SCHIFFINO CHECKED BY: JBK

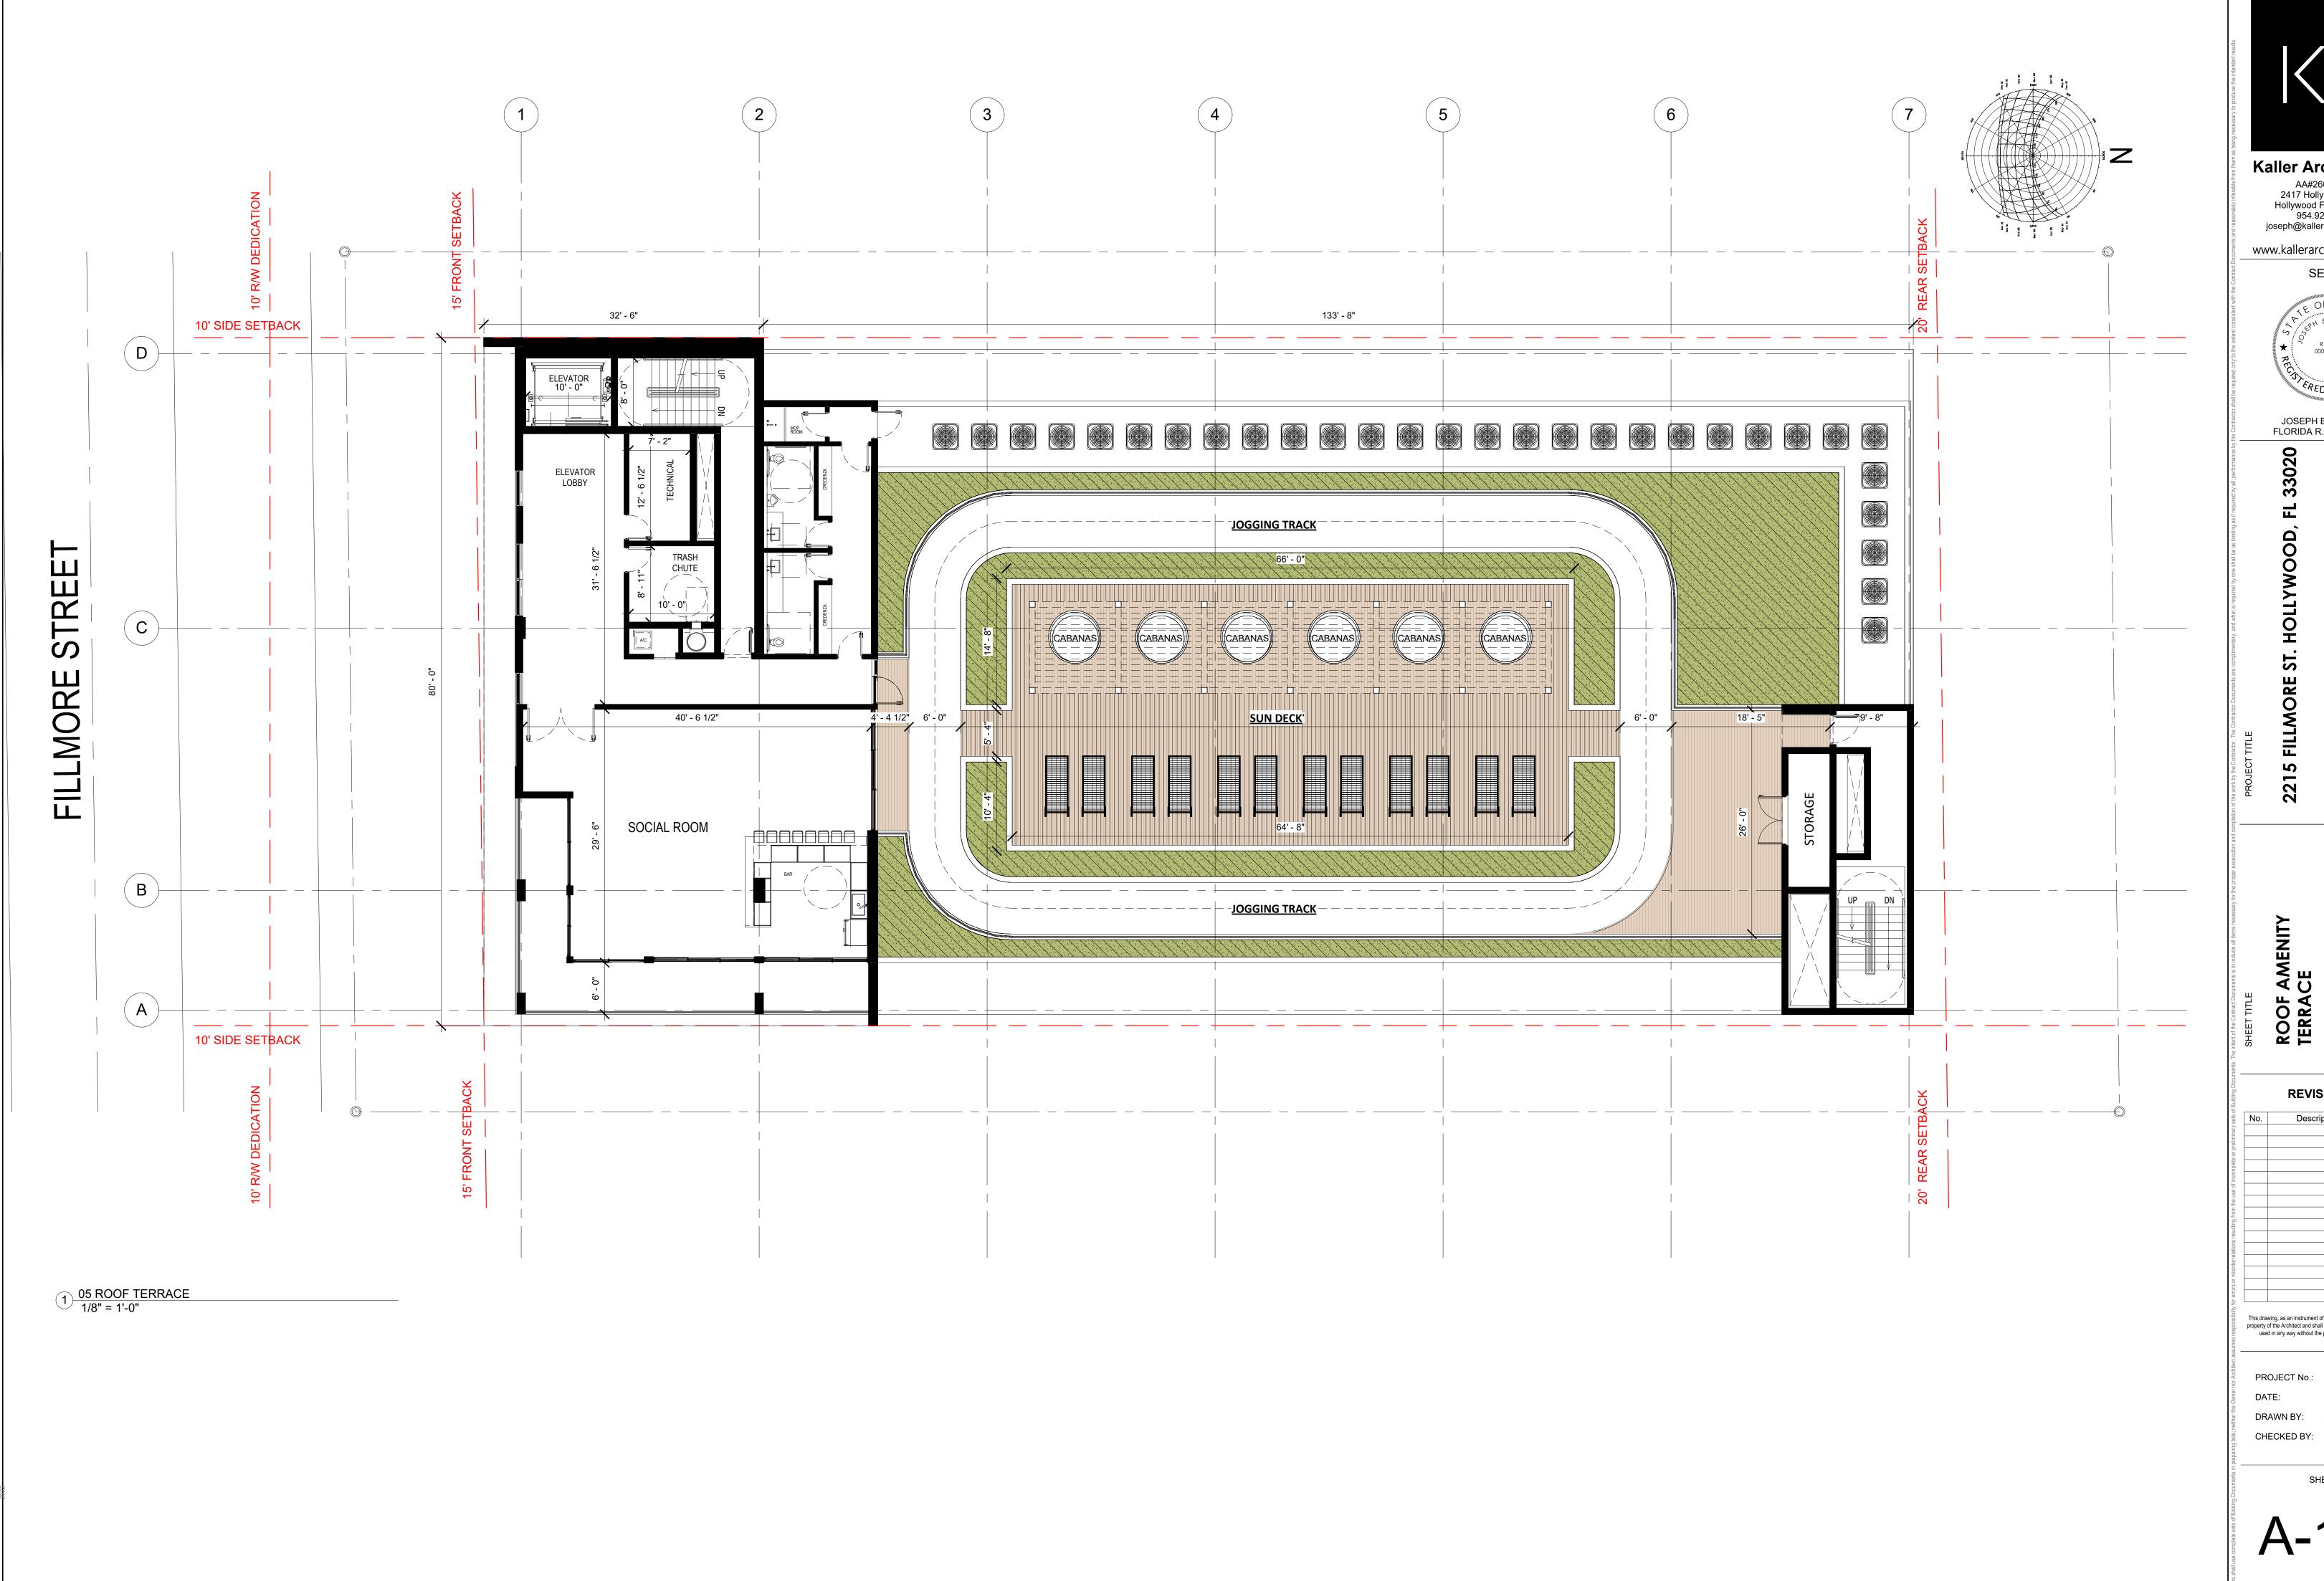

Kaller Architecture AA#26001212 2417 Hollywood Blvd. Hollywood Florida 33020 954.920.5746 joseph@kallerarchitects.com

www.kallerarchitects.com

SEAL

JOSEPH B. KALLER FLORIDA R.A. #0009239

REVISIONS

This drawing, as an instrument of service, is and shall remain the property of the Architect and shall not be reproduced, published or used in any way without the permission of the Architect.

PROJECT No.: 22-219

DRAWN BY: SCHIFFINO CHECKED BY: JBK





Kaller Architecture

AA#26001212 2417 Hollywood Blvd. Hollywood Florida 33020 954.920.5746 joseph@kallerarchitects.com

www.kallerarchitects.com

JOSEPH B. KALLER FLORIDA R.A. #0009239

3D SCHEMATIC

REVISIONS

No.	Description	Date

This drawing, as an instrument of service, is and shall remain the property of the Architect and shall not be reproduced, published or used in any way without the permission of the Architect.

PROJECT No.: 22-219 DRAWN BY: SCHIFFINO


CHECKED BY: JBK





Kaller Architecture AA#26001212 2417 Hollywood Blvd. Hollywood Florida 33020 954.920.5746 joseph@kallerarchitects.com

www.kallerarchitects.com

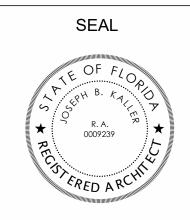

JOSEPH B. KALLER FLORIDA R.A. #0009239

SCHEMATIC PERSEPCTIVE

REVISIONS

This drawing, as an instrument of service, is and shall remain the property of the Architect and shall not be reproduced, published or used in any way without the permission of the Architect.

PROJECT No.: 22-219

DRAWN BY: SCHIFFINO CHECKED BY: JBK





Kaller Architecture AA#26001212 2417 Hollywood Blvd. Hollywood Florida 33020 954.920.5746 joseph@kallerarchitects.com

www.kallerarchitects.com

JOSEPH B. KALLER FLORIDA R.A. #0009239

SCHEMATIC PERSPECTIVES

REVISIONS

No.	Description	Date

This drawing, as an instrument of service, is and shall remain the property of the Architect and shall not be reproduced, published or used in any way without the permission of the Architect.


PROJECT No.: 22-219 DRAWN BY: SCHIFFINO CHECKED BY: JBK





AA#26001212
2417 Hollywood Blvd.
Hollywood Florida 33020
954.920.5746
joseph@kallerarchitects.com

www.kallerarchitects.com

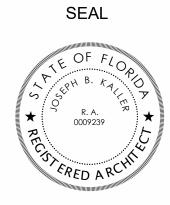

JOSEPH B. KALLER FLORIDA R.A. #0009239

| CLYWOOD, FL 33020

PROJECT TILLE

NORTH & SOUTH ELEVATIONS

REVISIONS

No.	Description	Date
his dra	wing, as an instrument of service, is and shal	I remain the


This drawing, as an instrument of service, is and shall remain the property of the Architect and shall not be reproduced, published or used in any way without the permission of the Architect.

PROJECT No.: 22-219
DATE: 1/16/23

DRAWN BY: SCHIFFINO
CHECKED BY: JBK

SHEET

A-1.7

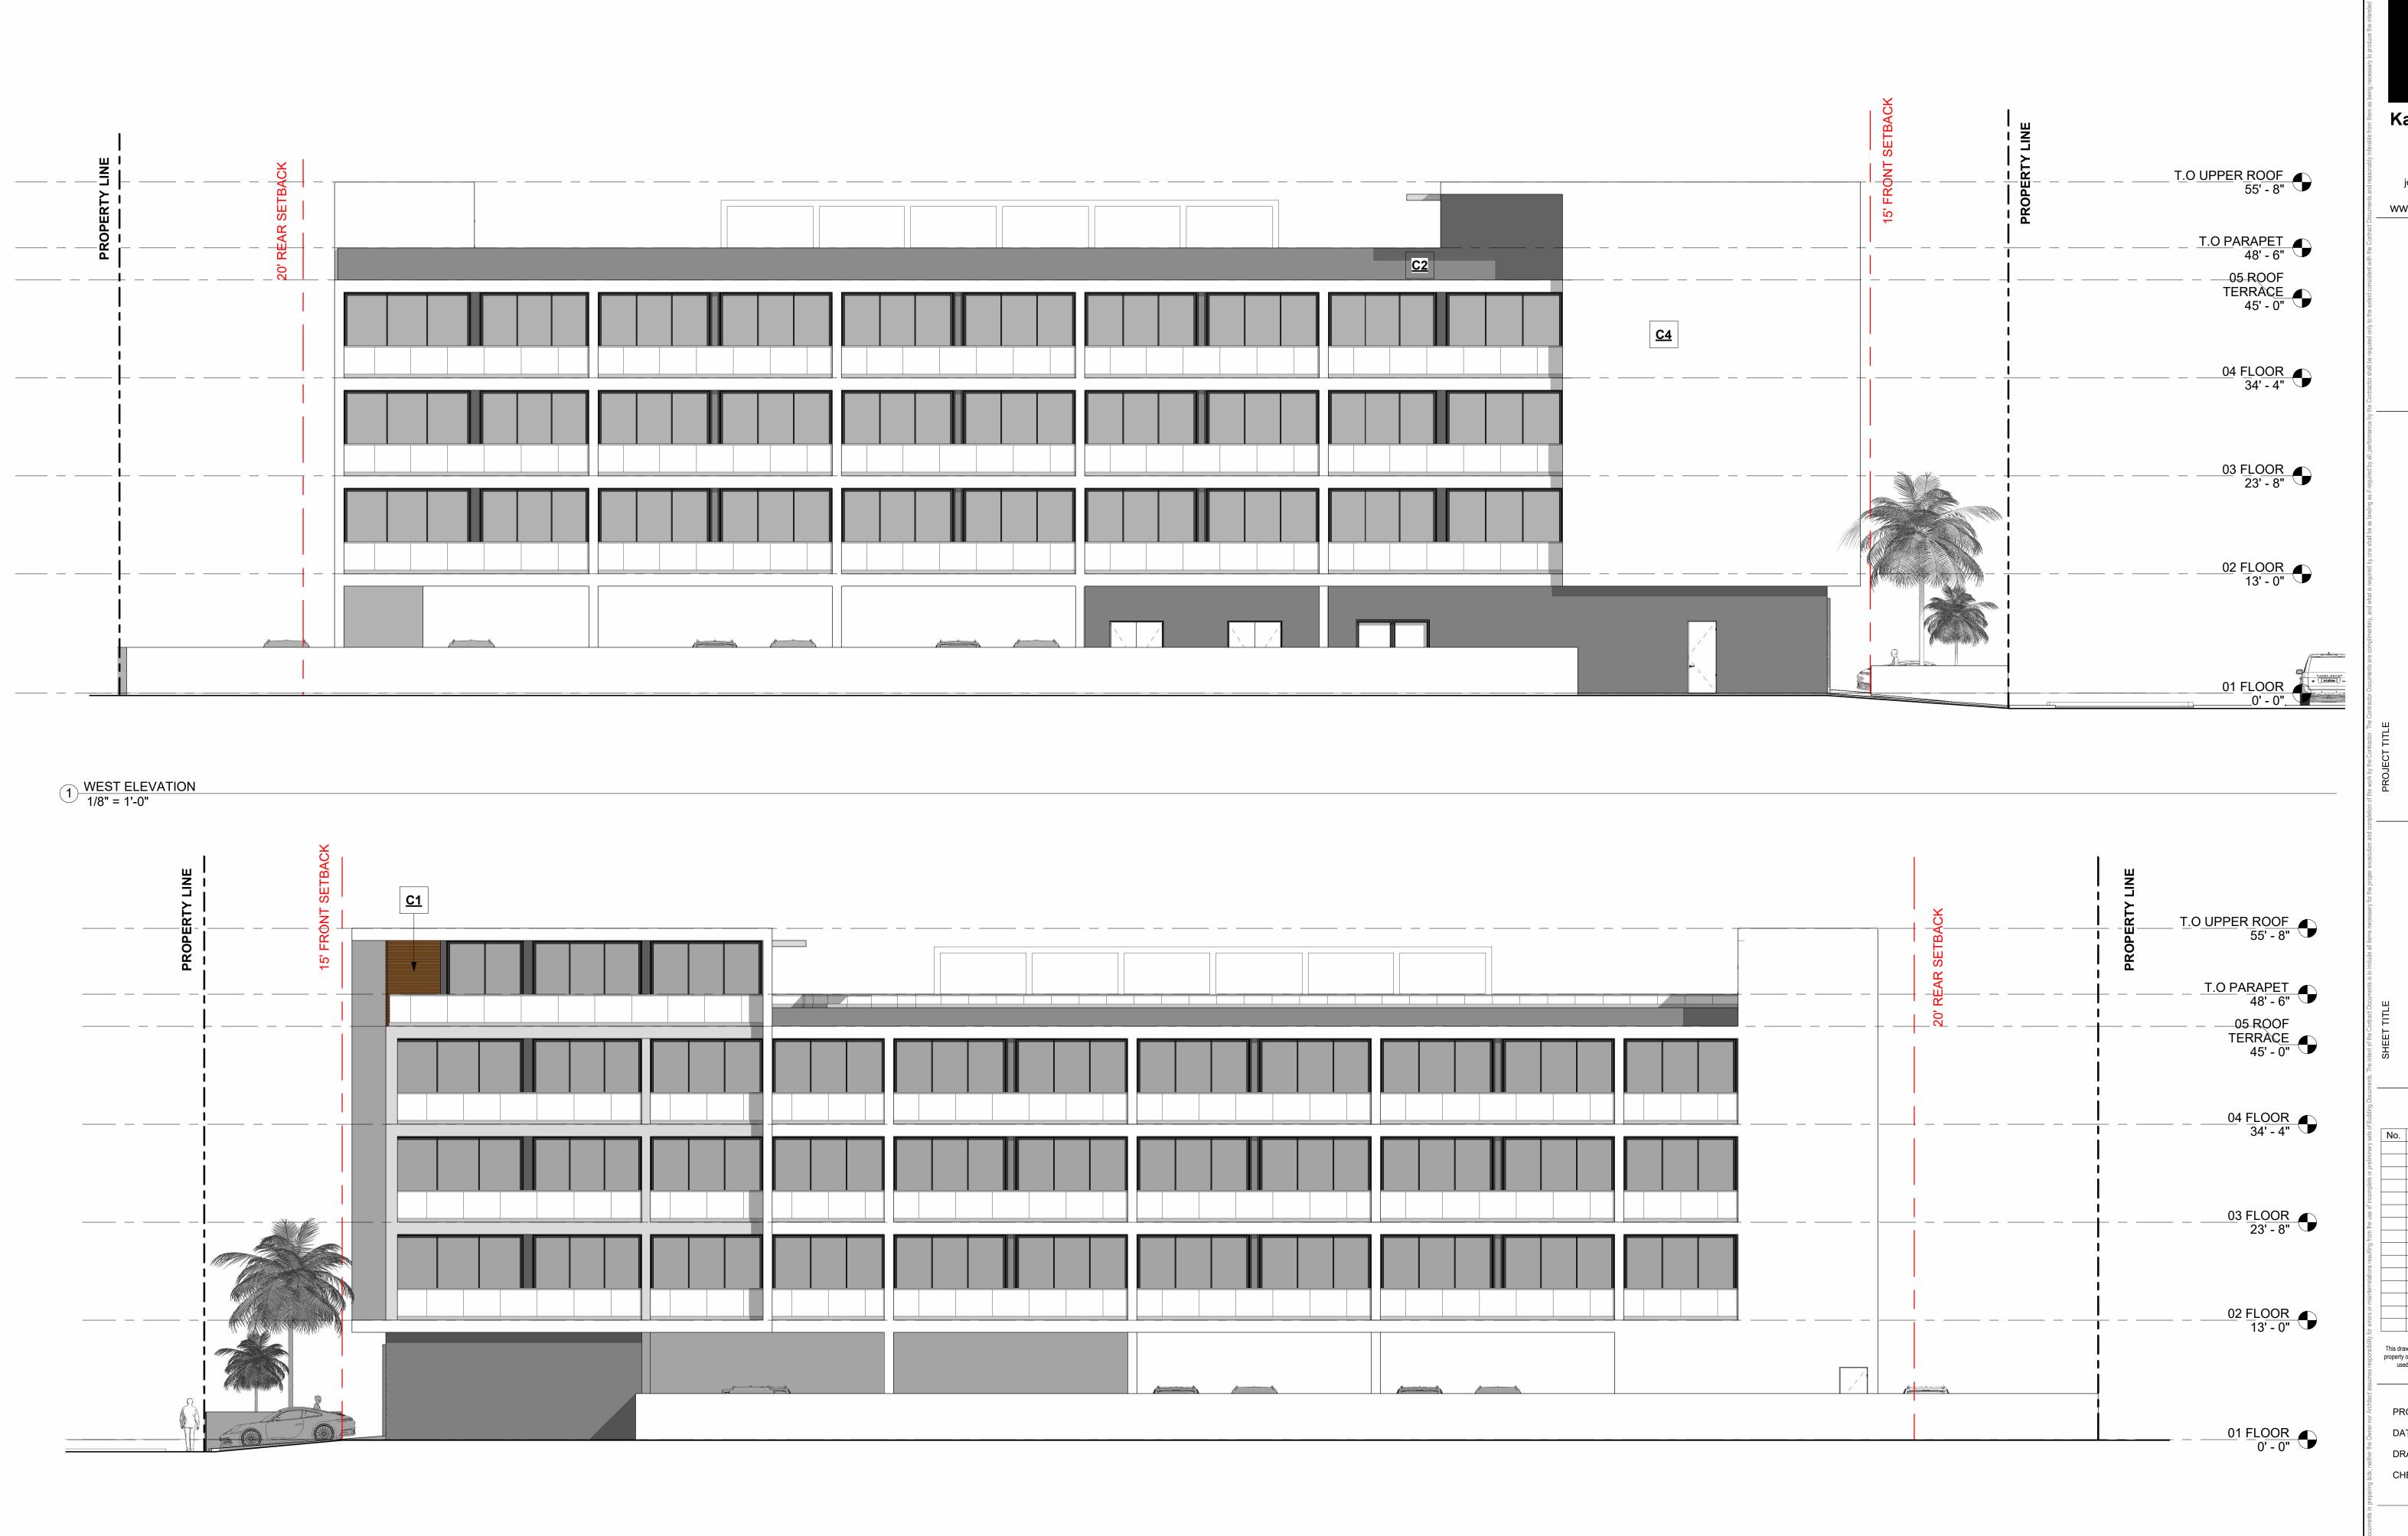

2 EAST ELEVATION 1/8" = 1'-0" Kaller Architecture

AA#26001212
2417 Hollywood Blvd, Hollywood Florida 33020
954.920.5746
joseph@kallerarchitects.com

www.kallerarchitects.com

SEAL

JOSEPH B. KALLER
FLORIDA R. A. #0009239

JOSEPH B. KALLER
FLORIDA R. A. #0009239

EAST & WEST ELEVATIONS

REVISIONS

No. Description Date


This drawing, as an instrument of service, is and shall remain the property of the Architect and shall not be reproduced, published or used in any way without the permission of the Architect.

used in any way without the permission of the Archite

DATE: 1/16/23
DRAWN BY: SCHIFFINO
CHECKED BY: JBK

SHEET


A-1.8

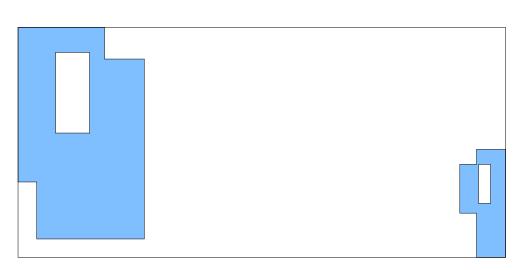


ROOFTOP FAR: 2,792 SF

\$ \$	44	\$ \$	$\Diamond \Diamond$
♦	♦ ♦ ♦	♦	♦ ♦


FOURTH FLOOR FAR: 10,133 SF

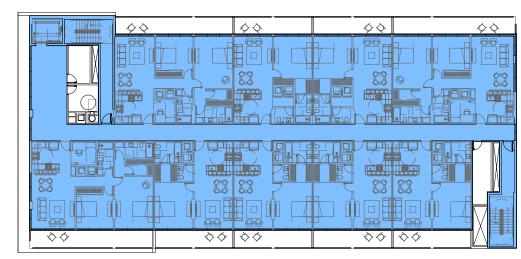

THIRD FLOOR FAR: 10,133 SF

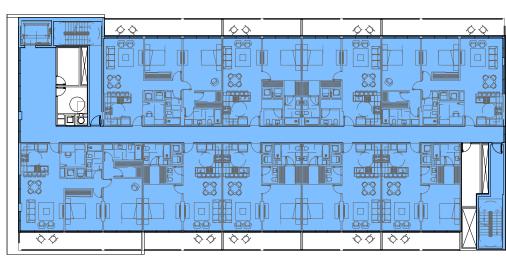

SECOND FLOOR FAR: 10,133 SF

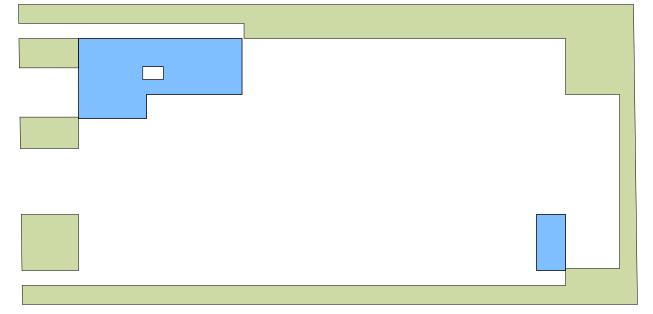

20,502 SF **NET LOT AREA REQUIRED PROVIDED** 34,617 SF 1.75(35,828 SF) **MAX FAR**


GROUND FLOOR FAR: 1,426 SF

1 FLOOR AREA RATIO 1/32" = 1'-0"




TOTAL GROSS ROOFTOP AREA 12,513 SF **PROVIDED** 22% **MAX COVERED ROOF AREA**

2 ROOF COVERED AREA 1/32" = 1'-0"

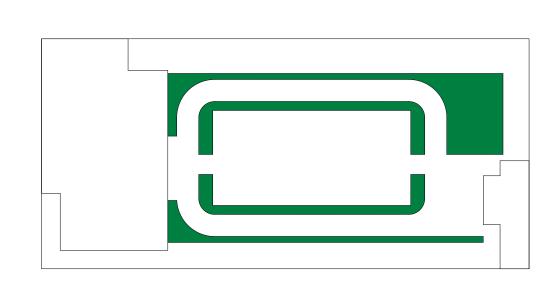

ROOFTOP TERRACE ADDITIONAL LANDSCAPE AREA - 1,759 SF

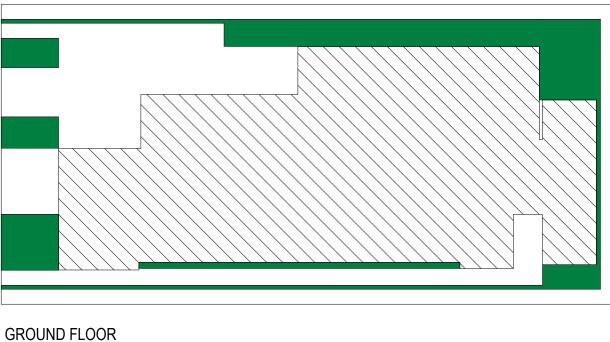

GROUND FLOOR TOTAL VEHICLULAR USE - 10,747 SF

LANDSCAPE AREA - 3,301 SF

3 VEHICULAR USE AREA 1/32" = 1'-0"

TOTAL LOT AREA

VEHICULAR USE (V.U.A)

LANDSCAPE AREA


10,747 SF X 25% = 2,686 SF REQUIRED PROVIDED 5,060 SF 2,686 SF

20,502 SF

NOTE: CALCULATION EXCLUDES LANDSCAPE BUFFERS

Kaller Architecture AA#26001212 2417 Hollywood Blvd. Hollywood Florida 33020 954.920.5746 joseph@kallerarchitects.com

www.kallerarchitects.com

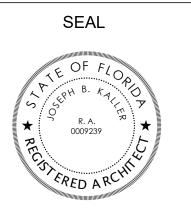



JOSEPH B. KALLER FLORIDA R.A. #0009239

DIAGRAMS

REVISIONS This drawing, as an instrument of service, is and shall remain the property of the Architect and shall not be reproduced, published or used in any way without the permission of the Architect.

PROJECT No.: 22-219 DRAWN BY: SCHIFFINO CHECKED BY: JBK

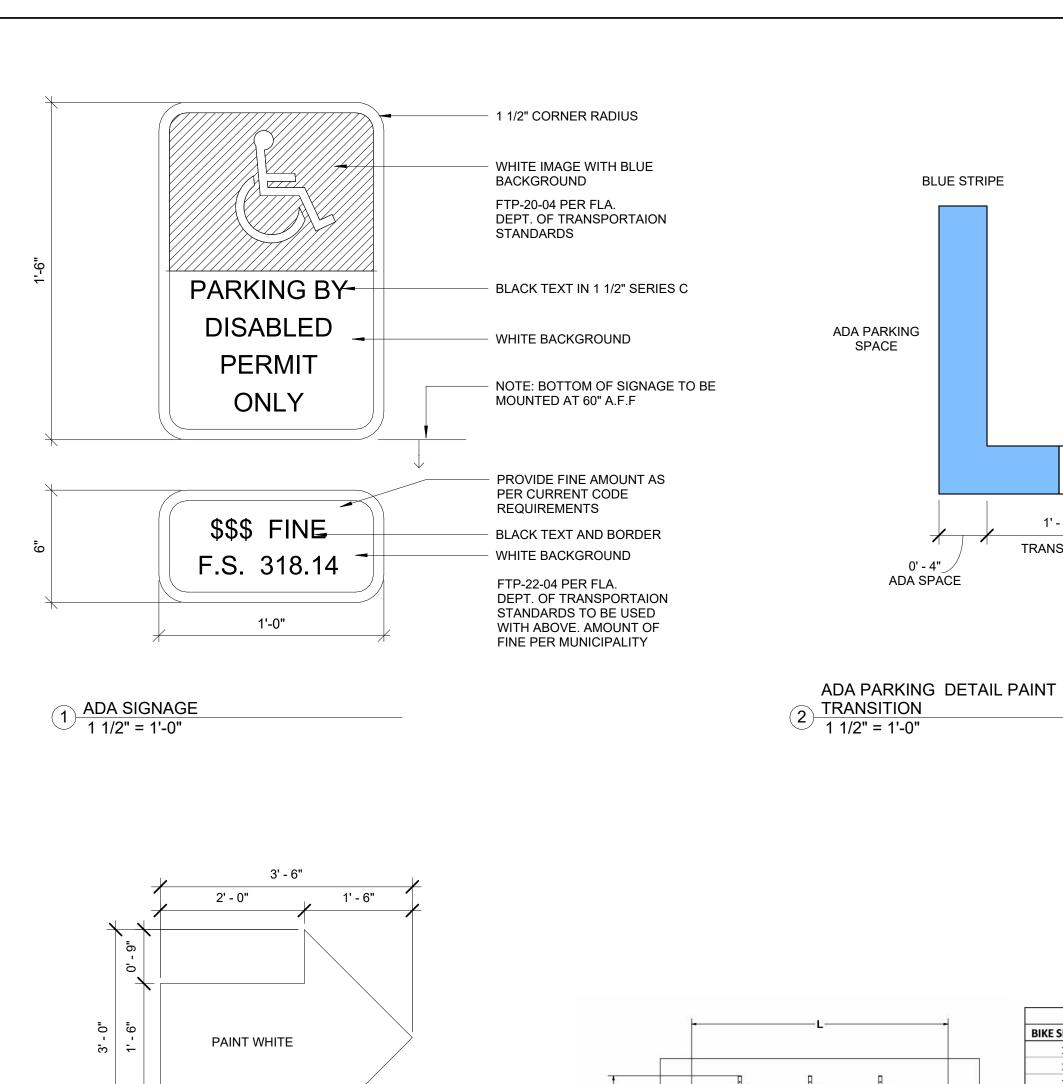

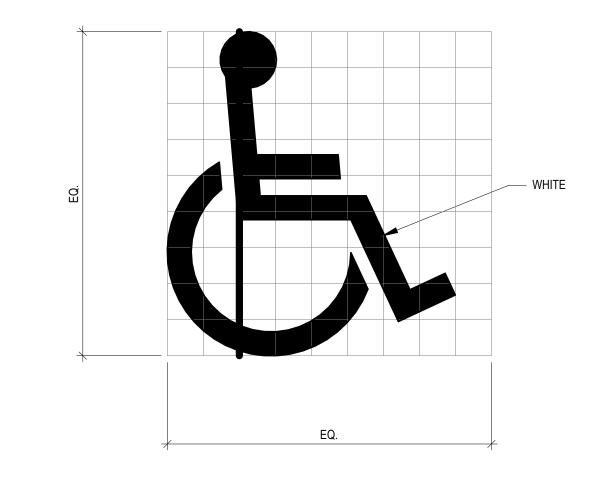

3 ADA PARKING SPACE SIGNAGE 1 1/2" = 1'-0"

WHITE STRIPE


1' - 0"


TRANSITION

STANDARD PARKING


SPACE

STANDARD SPACE

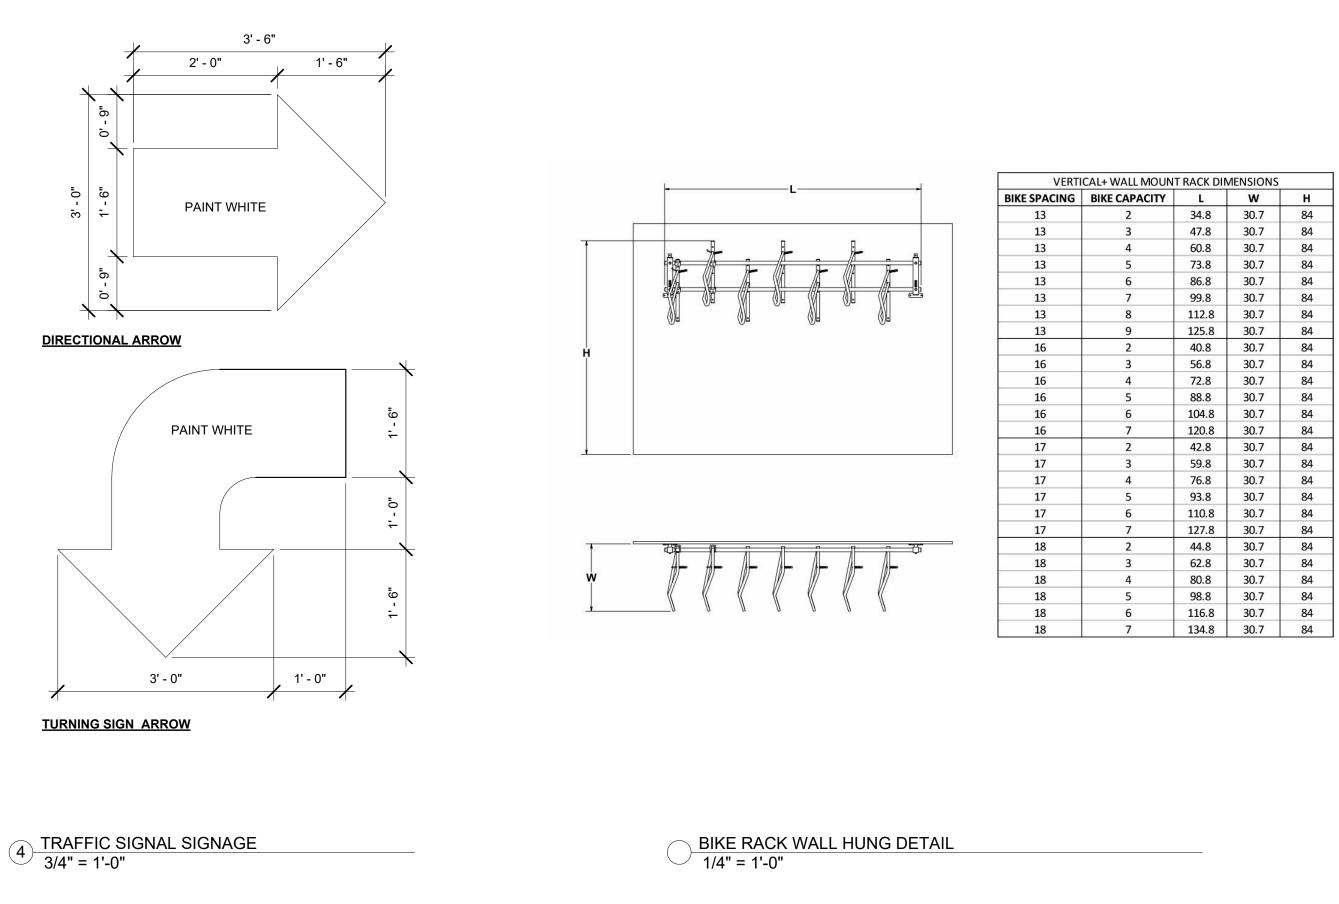

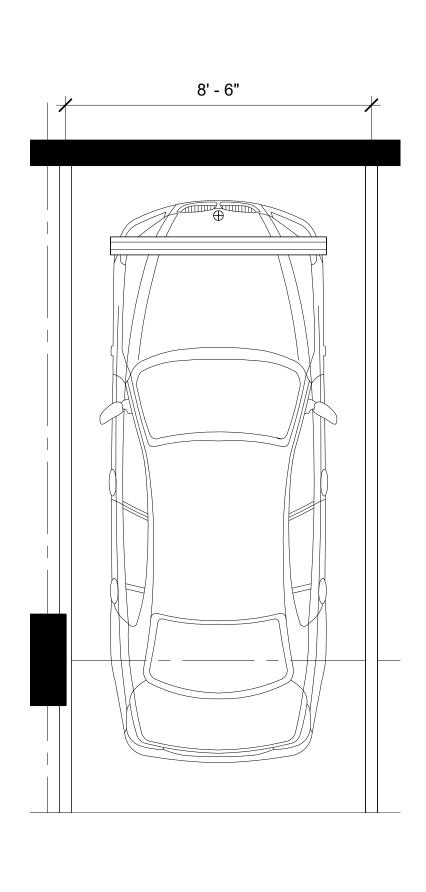



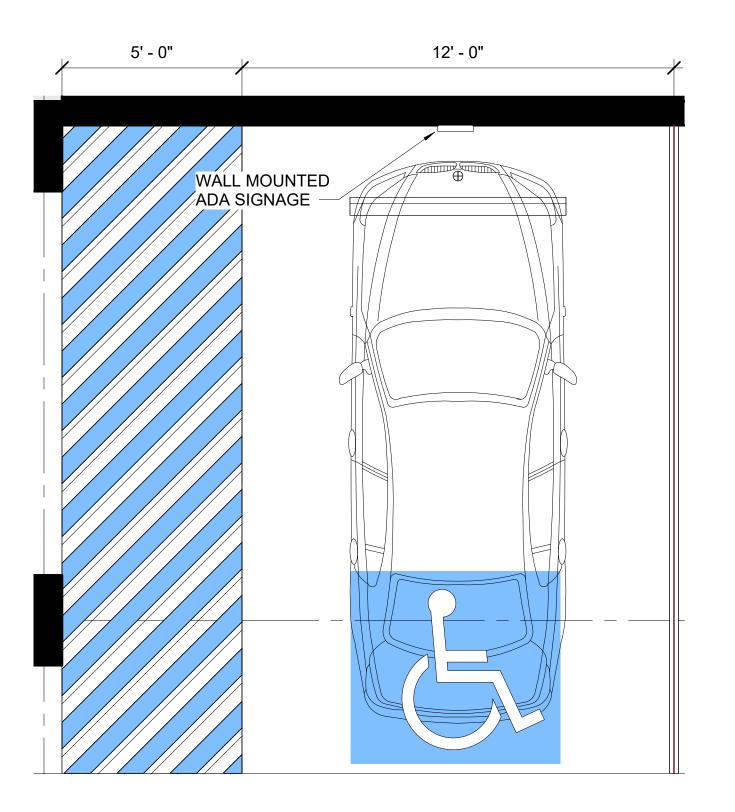

6 TYP. ADA PARKING SPACE 3/8" = 1'-0"

Kaller Architecture AA#26001212 2417 Hollywood Blvd. Hollywood Florida 33020 954.920.5746 joseph@kallerarchitects.com

www.kallerarchitects.com

SEAL

JOSEPH B. KALLER FLORIDA R.A. #0009239


DETAILS

REVISIONS

This drawing, as an instrument of service, is and shall remain the property of the Architect and shall not be reproduced, published or used in any way without the permission of the Architect.

PROJECT No.: 22-219 DRAWN BY: SCHIFFINO

CHECKED BY: JBK

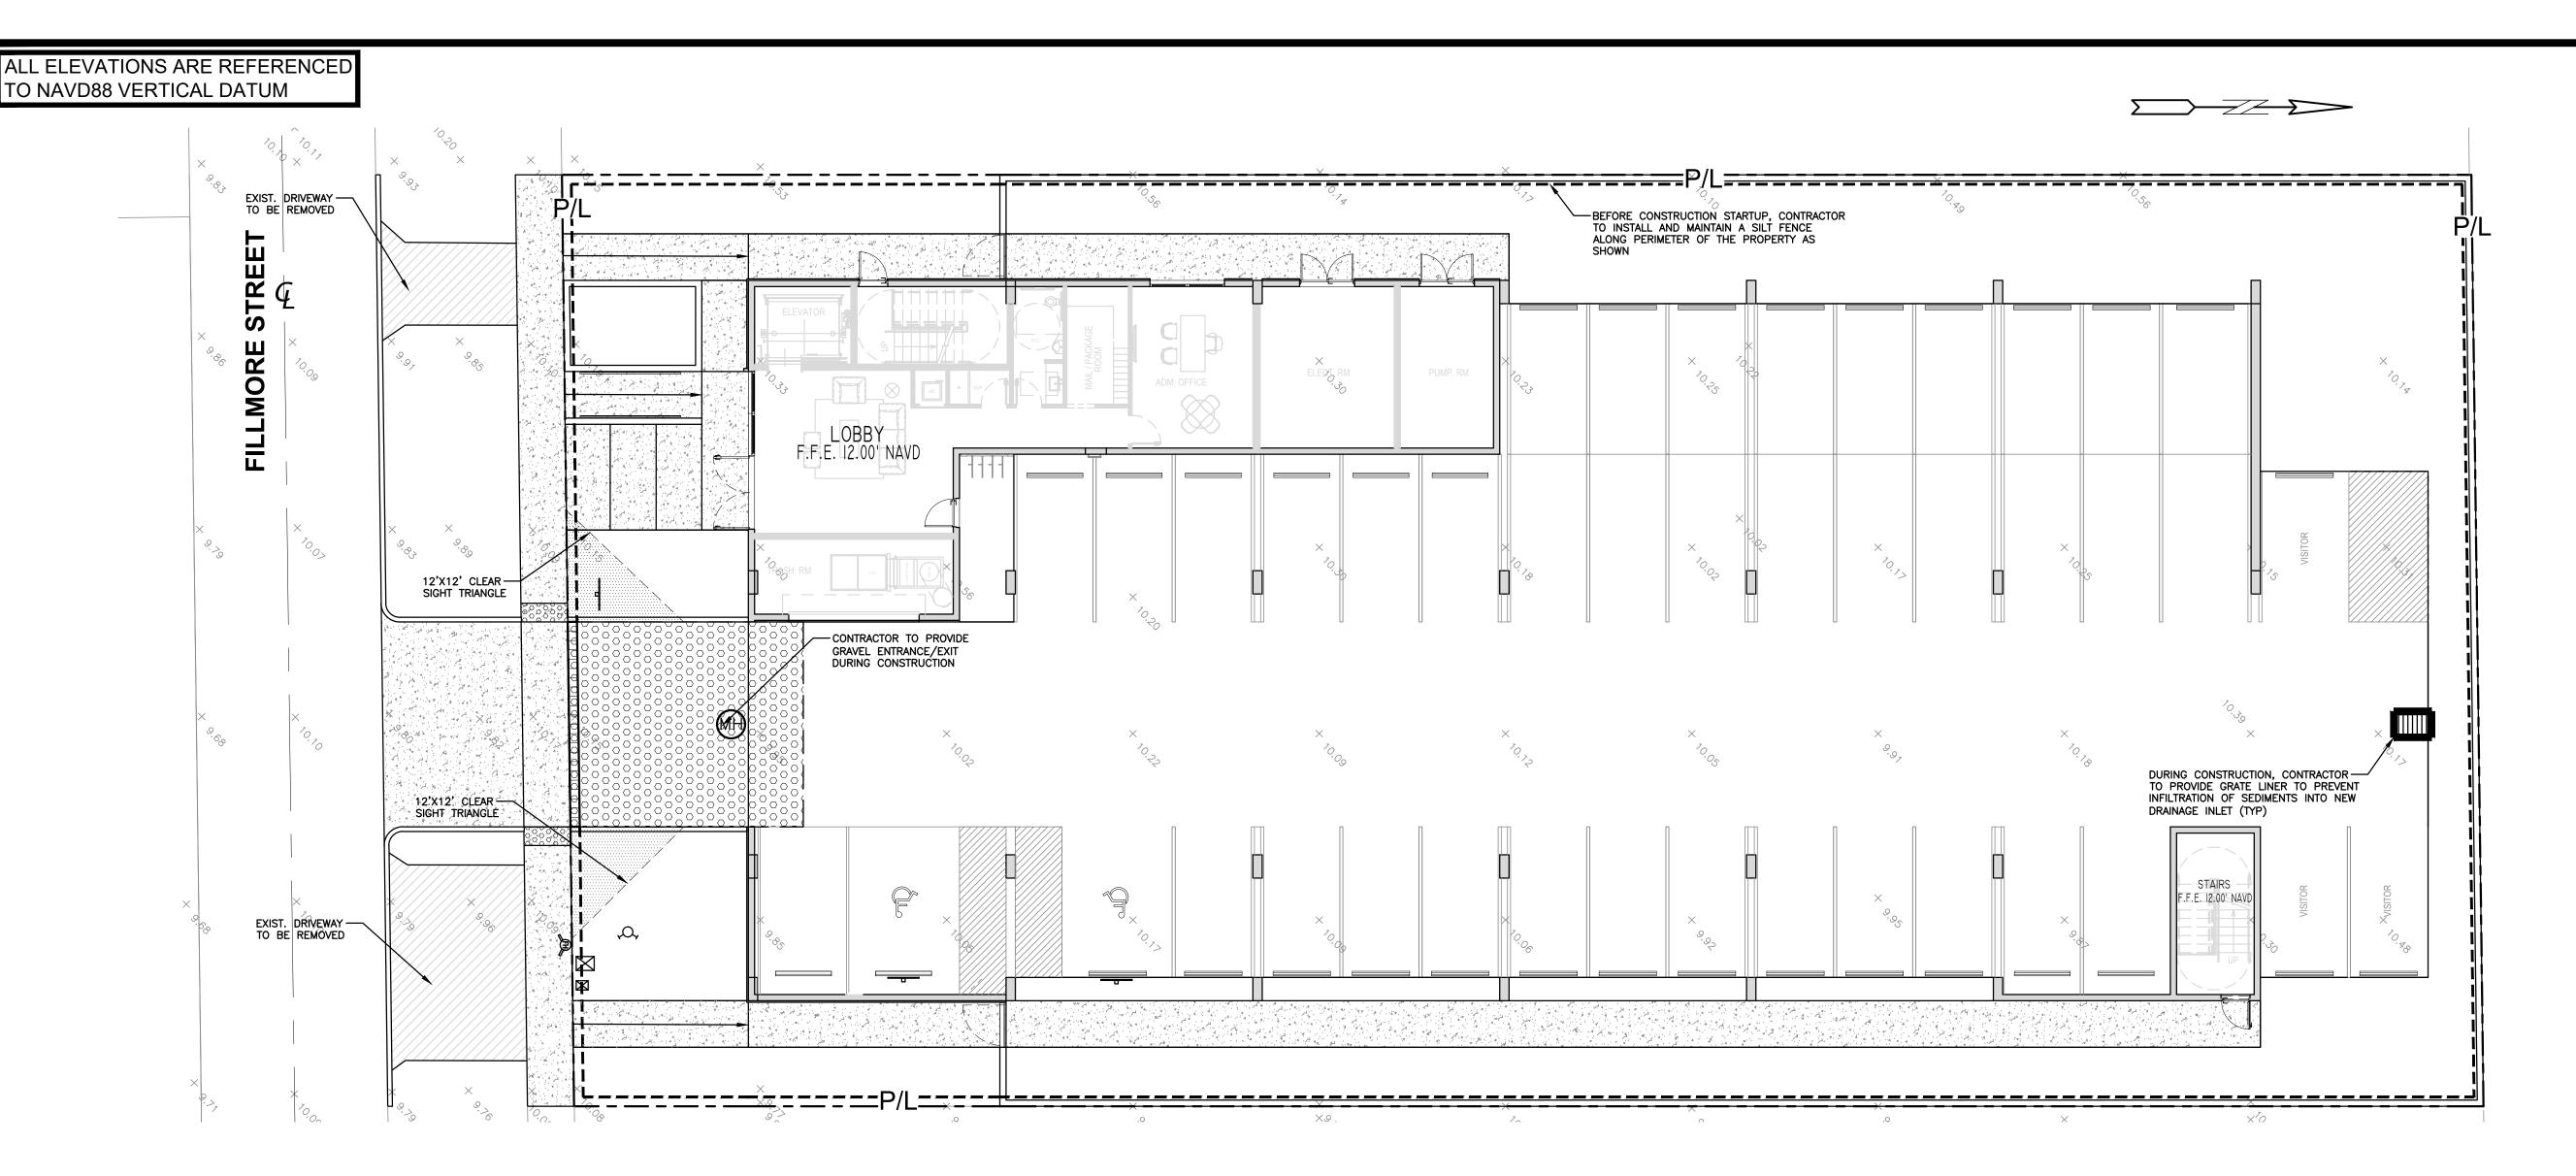

BMP NOTES:

. ALL SEDIMENT CONTROL MEASURES ARE TO BE ADJUSTED TO MEET FIELD CONDITIONS AT THE TIME OF CONSTRUCTION AND BE CONSTRUCTED PRIOR TO ANY GRADING OR DISTURBANCE OF EXISTING SURFACE MATERIAL ON BALANCE OF SITE. PERIMETER SEDIMENT BARRIERS SHALL BE CONSTRUCTED TO PREVENT SEDIMENT OR TRASH FROM FLOWING OR FLOATING ON TO ADJACENT

2. PERIODIC INSPECTION AND MAINTENANCE OF ALL SEDIMENT CONTROL STRUCTURES MUST BE PROVIDED TO ENSURE INTENDED PURPOSE IS ACCOMPLISHED. THE DEVELOPER, OWNER AND/OR CONTRACTOR SHALL BE CONTINUALLY RESPONSIBLE FOR ALL SEDIMENT CONTROLS. SEDIMENT CONTROL MEASURES SHALL BE IN WORKING CONDITION AT THE END OF EACH WORKING DAY.

3. SEDIMENT WILL BE PREVENTED FROM ENTERING ANY STORM WATER SYSTEM, DITCH OR CHANNEL. ALL STORMWATER INLETS THAT ARE MADE OPERABLE DURING CONSTRUCTION SHALL BE PROTECTED SO THAT SEDIMENT-LADEN WATER CANNOT ENTER THE CONVEYANCE SYSTEM WITHOUT FIRST BEING FILTERED OR OTHERWISE TREATED TO REMOVE SEDIMENT.

4. WHERE CONSTRUCTION VEHICLE ACCESS ROUTES INTERSECT PAVED PUBLIC ROADS, PROVISIONS SHALL BE MADE TO MINIMIZE THE TRANSPORT OF SEDIMENT BY TRACKING ONTO THE PAVED SURFACE. WHERE SEDIMENT IS TRANSPORTED ONTO A PUBLIC ROAD SURFACE WITH CURBS AND GUTTERS, THE ROAD SHALL BE CLEANED THOROUGHLY AT THE END OF EACH DAY. SEDIMENT SHALL BE REMOVED FROM THE ROADS BY SHOVELING OR SWEEPING AND TRANSPORTED TO A SEDIMENT CONTROL DISPOSAL AREA. STREET WASHING SHALL BE ALLOWED ONLY AFTER SEDIMENT IS REMOVED IN THIS MANNER. THIS PROVISION SHALL APPLY TO INDIVIDUAL SUBDIVISION LOTS AS WELL AS TO LARGER LAND DISTURBING ACTIVITIES.

5. PERMANENT OR TEMPORARY SOIL STABILIZATION SHALL BE APPLIED TO DENUDED AREAS WITHIN \mid SEVEN (7) DAYS AFTER FINAL GRADE IS REACHED ON ANY PORTION OF THE SITE. TEMPORARY SOIL \mid STABILIZATION SHALL BE APPLIED WITHIN SEVEN (7) DAYS TO DENUDED AREAS THAT MAY NOT BE AT FINAL GRADE BUT WILL REMAIN UNDISTURBED FOR LONGER THAN THIRTY (30) DAYS. PERMANENT STABILIZATION SHALL BE APPLIED TO AREAS THAT ARE TO BE LEFT UNDISTURBED FOR MORE THAN ONE YEAR.

6. DURING CONSTRUCTION OF THE PROJECT, SOIL STOCKPILES SHALL BE STABILIZED, COVERED OR CONTAINED WITH SEDIMENT TRAPPING MEASURES. THE CONTRACTOR IS RESPONSIBLE FOR THE TEMPORARY PROTECTION AND PERMANENT STABILIZATION OF ALL SOIL STOCKPILES ON SITE AS WELL AS SOIL INTENTIONALLY TRANSPORTED FROM THE PROJECT SITE.


7. ALL TEMPORARY EROSION AND SEDIMENT CONTROL MEASURES SHALL BE REMOVED WITHIN 30 DAYS AFTER FINAL SITE STABILIZATION OR AFTER THE TEMPORARY MEASURES ARE NO LONGER


8. PROPERTIES AND WATER WAYS DOWNSTREAM FROM CONSTRUCTION SITE SHALL BE PROTECTED FROM SEDIMENT DEPOSITION AND EROSION AT ALL TIMES DURING CONSTRUCTION.


9. CONTRACTOR IS RESPONSIBLE FOR ALL SURFACE WATER DISCHARGES, RAINFALL RUN OFF OR DEWATERING ACTIVITIES.

10. CONTRACTOR MUST INCORPORATE ALL BMP'S NECESSARY TO MEET OR EXCEED STATE WATER QUALITY AND SWPPP REQUIREMENTS.

11. THE POLLUTION PREVENTION PLAN IS A MINIMUM GUIDELINE ONLY. ADDITIONAL BMP'S MAY BE NECESSARY AT CONTRACTOR'S EXPENSE.

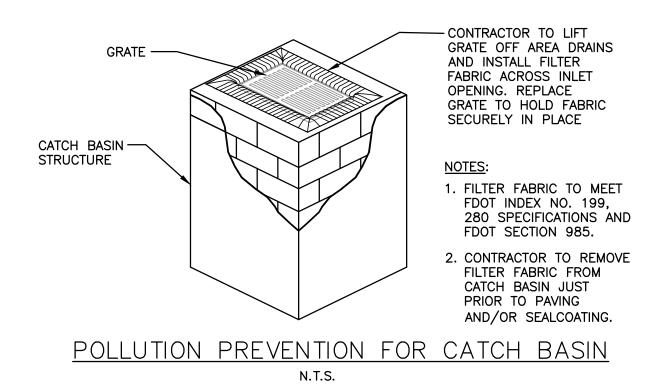

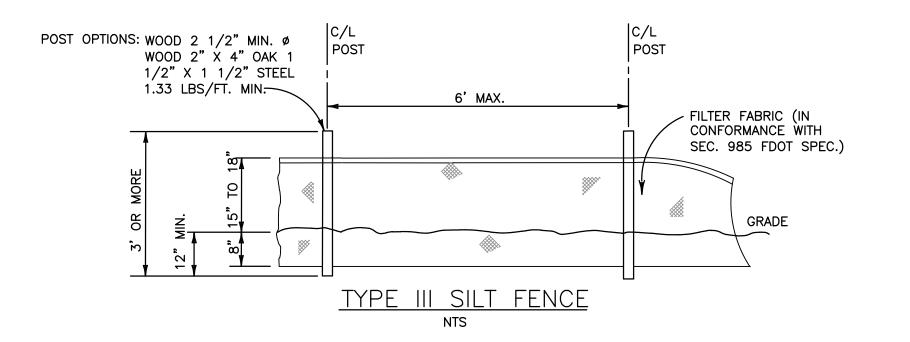

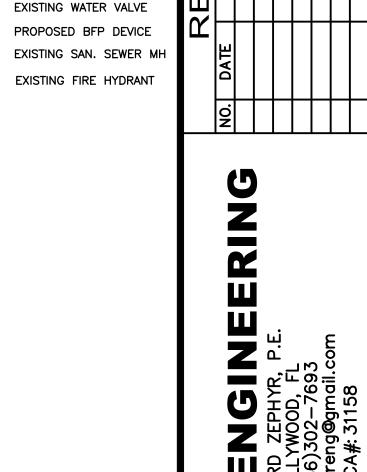

LEGEND

PROPOSED CONCRETE

PROPOSED ASPHALT PROPOSED GRADE EXISTING ELEVATION

PROPOSED CATCH BASIN

EXISTING CATCH BASIN PROPOSED WATER METER

EXISTING WATER METER

ZEPH

П 5



P.E.#:76036


SCALE: 1"=10'

THIS ITEM HAS BEEN DIGITALLY SIGNED AND SEALED BY WILFORD ZEPHYR ON THE DATE ADJACENT TO THE SEAL.

PRINTED COPIES OF THIS DOCUMENT ARE NOT CONSIDERED SIGNED AND SEALED AND THE SIGNATURE MUST BE VERIFIED ON ANY ELECTRONIC COPIES.

DATE: 5/9/23

SHEET NO.: 1 OF 10 PROJECT NO.: 23-15

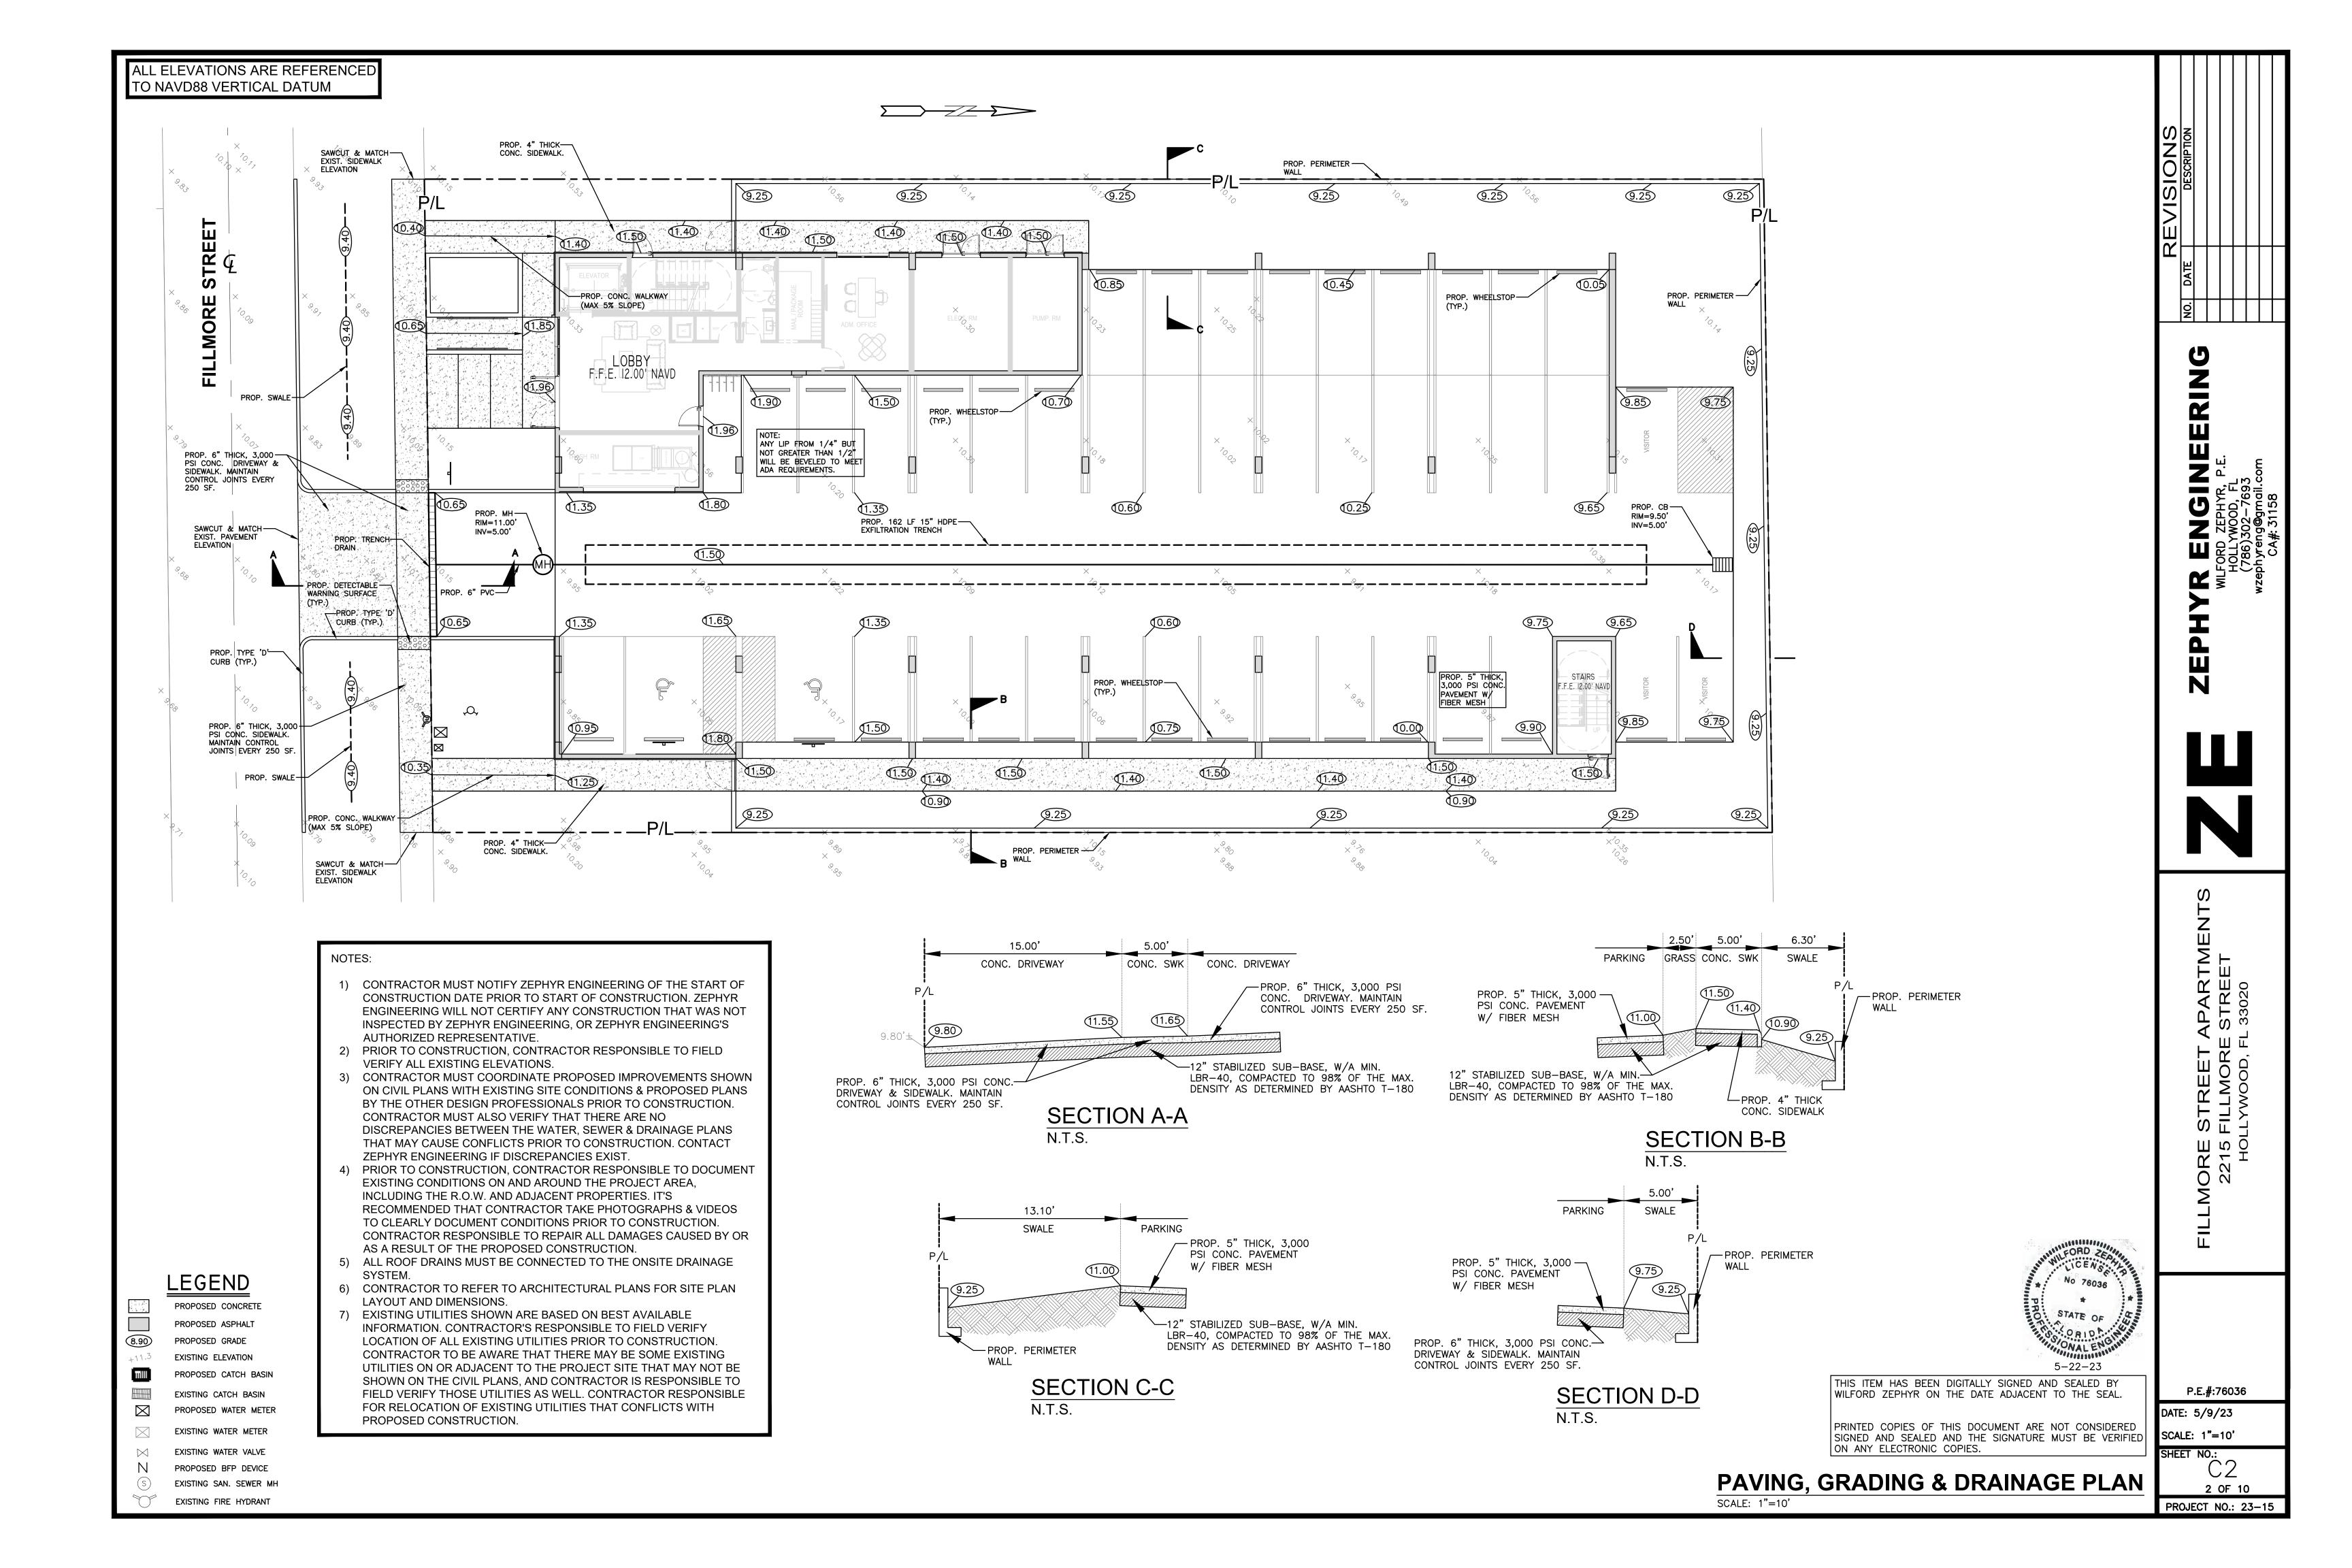

- THE LOCATION OF EXISTING UTILITIES AND TOPOGRAPHY HAS BEEN PREPARED FROM THE MOST RELIABLE INFORMATION AVAILABLE TO THE ENGINEER. THIS INFORMATION IS NOT GUARANTEED AND IT IS THE RESPONSIBILITY OF THE CONTRACTOR TO DETER-MINE THE EXACT LOCATION OF ALL EXISTING UTILITIES AND TOPOGRAPHY PRIOR TO CONSTRUCTION.
- 2. PRIOR TO CONSTRUCTION THE CONTRACTOR IS TO NOTIFY THE FOLLOWING COMPANIES & AGENCIES AND ANY OTHERS SERVING THE AREA:

FLORIDA POWER & LIGHT CO., CONSTRUCTION

BELLSOUTH COMCAST

LOCAL CITY / COUNTY ENGINEERING & UTILITY DEPARTMENTS FLORIDA DEPARTMENT OF TRANSPORTATION (FDOT), AS APPLICABLE UNDERGROUND UTILITIES NOIFICATION CENTER OF FLORIDA (S.U.N.S.H.I.N.E.)

PAVING, GRADING & DRAINAGE NOTES:

- ALL UNSUITABLE MATERIALS, SUCH AS MUCK, HARDPAN, ORGANIC MATERIAL & OTHER DELETERIOUS MATERIAL AS CLASSIFIED BY AASHTO M-145, FOUND WITHIN THE ROAD & PARKING LOT AREAS SHALL BE REMOVED DOWN TO ROCK OR SUITABLE MATERIAL, & REPLACED W/ THE SPECIFIED FILL MATERIAL IN MAXIMUM 12" LIFTS COMPACTED TO NOT LESS THAN 100% MAXIMUM DRY DENSITY AT OPTIMUM MOISTURE IN ACCORDANCE W/ AASHTO T-99. THICKNESS OF LAYERS MAY BE INCREASED PROVIDED THE EQUIPMENT & METHODS USED ARE PROVEN BY FIELD DENSITY TESTING TO BE CAPABLE OF COMPACTING THICK LAYERS TO SPECIFIED DENSITIES.
- 2. ALL AREAS SHALL BE CLEARED & GRUBBED PRIOR TO CONSTRUCTION. THIS SHALL CONSIST OF THE COMPLETE REMOVAL & DISPOSAL OF ALL TREES, BRUSH, STUMPS, ROOTS, GRASS, WEEDS, RUBBISH & ALL OTHER OBSTRUCTION RESTING ON OR PROTRUDING THROUGH THE SURFACE OF THE EXIST. GROUND TO A DEPTH OF 12". ITEMS DESIGNATED TO REMAIN OR TO BE RELOCATED OR ADJUSTED SHALL BE SO DESIGNATED ON THE DWGS.
- 3. FILL MATERIAL SHALL BE CLASSIFIED AS A-1, A-3 OR A-2.4 IN ACCORDANCE W/ AASHTO M-145 & SHALL BE FREE FROM VEGETATION & ORGANIC MATERIAL. NOT MORE THAN 12% BY WEIGHT OF FILL MATERIAL SHALL PASS THE NO. 200 SIEVE.
- 4. THE CONTRACTOR SHALL BE RESPONSIBLE FOR PROVIDING CERTIFIED MATERIAL TEST RESULTS TO THE ENGINEER OF RECORD PRIOR TO THE RELEASE OF FINAL CERTIFICATION BY THE ENG. TEST RESULTS MUST INCLUDE BUT MAY NOT BE LIMITED TO, DENSITIES FOR SUBGRADE & LIME ROCK, UTILITIES, EXCAVATION, ASPHALT GRADIATION REPORTS, CONC. CYLINDERS, ETC...
- 5. ALL INLETS & PIPE SHALL BE PROTECTED DURING CONSTRUCTION TO PREVENT SILTATION IN THE DRAINAGE SYSTEMS BY WAY OF TEMPORARY PLUGS & PLYWOOD OR PLASTIC COVERS OVER THE INLETS. THE ENTIRE DRAINAGE SYSTEM TO BE CLEAN OF DEBRIS PRIOR TO FINAL
- 6. WHERE NEW ASPHALT MEETS OR ABUTS EXIST. ASPHALT, THE EXIST. ASPHALT SHALL BE SAWCUT TO PROVIDE A STRAIGHT EVEN LINE. PRIOR TO REMOVING CURB OR GUTTER, THE ADJACENT ASPHALT SHALL ALSO BE SAWCUT TO PROVIDE A STRAIGHT EVEN LINE.
- 7. ALL PROPOSED GRADES (ELEVATIONS) REFER TO ASPHALT GRADES UNLESS INDICATED
- OTHERWISE. 8. SITE GRADING SHALL BE W/IN 0.1' OF THE REQUIRED ELEVATION & ALL AREAS SHALL BE
- GRADED TO DRAIN. 9. ALL SUBGRADE SHALL HAVE AN LBR OF 40 UNLESS OTHERWISE NOTED & SHALL BE

COMPACTED TO 98% MAXIMUM DRY DENSITY PER AASHTO T-99.

- 10. ALL LIMEROCK SHALL BE COMPACTED TO 98% PER AASHTO T-180 & HAVE NOT LESS THAN 60% OF CARBONATES OF CALCIUM & MAGNESIUM UNLESS OTHERWISE DESIGNATED. ALL
- LIMEROCK SHALL BE PRIMED. 11 CONCRETE & ASPHALT THICKNESS SHALL BE OF TYPE DESIGNATED ON DWGS. (SEE SECTIONS)
- 12. PLASTIC FILTER FABRIC SHALL BE MIRAFI, TYPAR OR EQUAL CONFORMING TO SECTION 985 OF THE FDOT STANDARD SPECIFICATIONS.
- 13. CONC. SIDEWALKS SHALL BE 4" THICK ON COMPACTED SUBGRADE, W/ 1/2" EXPANSION JOINTS PLACED AT A MAXIMUM OF 75'. CRACK CONTROL JOINTS SHALL BE 5' ON CENTER. THE BACK OF SIDEWALK ELEVATION SHALL EQUAL THE CROWN OF ROADWAY. UNLESS SPECIFIED OTHERWISE BY LOCAL CODES OR INDICATED ON DWGS. ALL CONC. SIDEWALKS THAT CROSS DRIVEWAYS SHALL BE 6" THICK.
- 14. PIPE SPECIFICATIONS: THE MATERIAL TYPE IS SHOWN ON THE DRAWINGS BY ONE OF THE FOLLOWING DESIGNATIONS -
 - RCP = REINFORCED CONC. PIPE, ASTM DESIGNATION C-76, TABLE III
 - CMP = CORRUGATED METAL (ALUM.) PIPE, TM DESIGNATION M-196(SMOUTH LINED) CORRUGATED METAL (ALUM.) PIPE, ASTM DESIGNATION M-196
 - SCP = SLOTTED CONC. PIPE, FDOT SECTIONS 941 & 942 PVC = POLYVINYLCHLORIDE PIPE
 - PCMP = PERFORATED CMP, FDOT SECTION 945 DIP = DUCTILE IRON PIPE HDPE = HIGH DENSITY POLYETHYLENE PIPE.

15. ASPHALT -


BITUMINOUS MATERIAL SHALL BE ASPHALT CEMENT, VISCOSITY GRADE AC-20, CONFORMING TO THE REQUIREMENTS OF FDOT STANDARD SPECIFICATIONS, 1986 EDITION, SECTION 916-1. PRIME COAT SHALL BE CUT BACK ASPHALT, GRADE RC-70 OR RC-250 CONFORMING TO THE REQUIREMENTS SPECIFIED IN AASHTO DESIGNATION M-81-75 (1982). RATE - 0.10 GALS./S.Y. TACK COAT SHALL BE EMULSIFIED ASPHALT, GRADE RS-2 CONFORMING TO THE


REQUIREMENTS SPECIFIED IN AASHTO DESIGNATION M-140-82. RATE - 0.02 TO 0.08


DESIGN MIX SHALL CONFORM TO FDOT SECTION 331 UNLESS OTHERWISE SPECIFIED.


PAVEMENT MARKING & SIGNING STANDARD NOTES:


- 1. STOP SIGNS SHALL BE 30"x30" (R1-1), HIGH INTENSITY.
- 2. ALL SIGNS SHALL BE PLACED AT A HEIGHT NOT LESS THAN 5' & NOT GREATER THAN 7', THE HEIGHT IS MEASURED FROM THE BOTTOM OF THE SIGN TO THE EDGE OF NEAREST PAVEMENT. THE SIGN POST SHALL BE PLACED A MINIMUM OF 6' TO A MAXIMUM OF 12' FROM THE ADJACENT PAVEMENT, & A MINIMUM OF 6' FROM THE CROSS TRAFFIC
- 3. STOP BARS SHALL BE 24" WHITE.
- 4. ALL SITE PAVEMENT MARKINGS SHALL BE PAINT. (UNLESS INDICATED OTHERWISE)
- 5. ALL PAVEMENT MARKINGS AND SIGNAGE IN THE ROAD RIGHT-OF-WAY SHALL BE THERMOPLASTIC & SHALL CONFORM TO MUTCD AND PBC TYPICAL T-P-06-001.

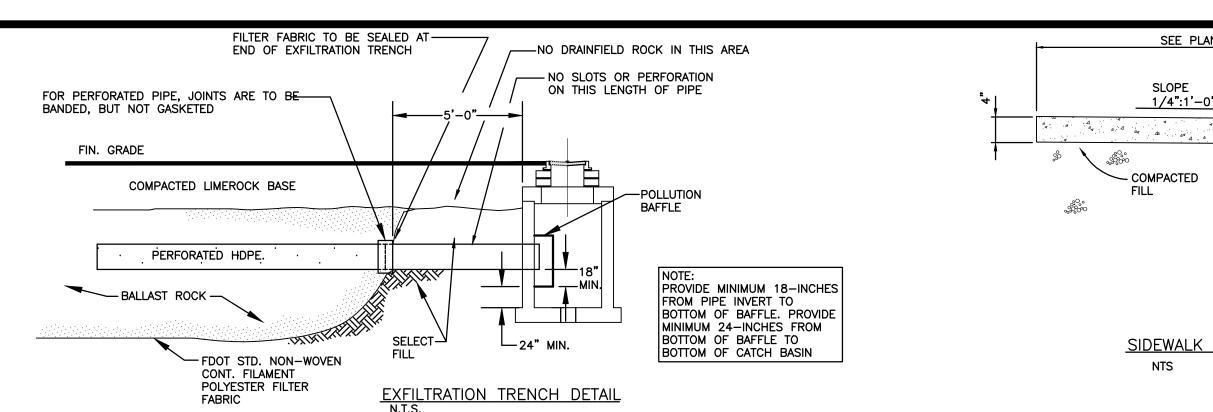

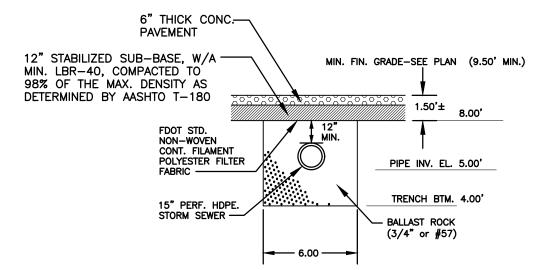

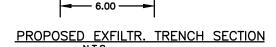

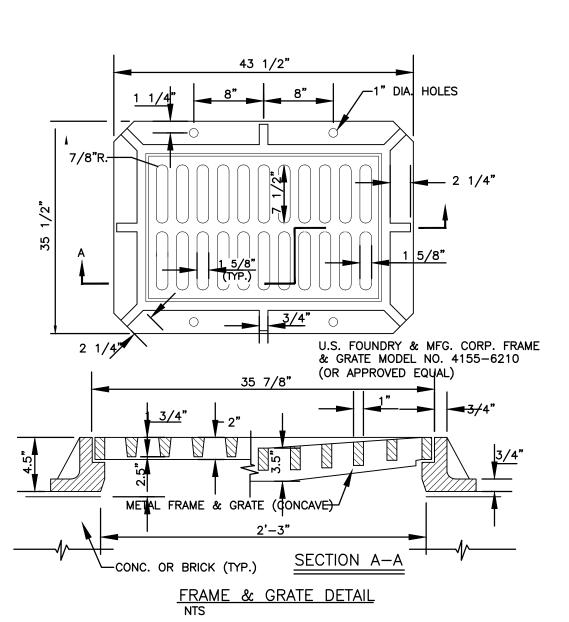

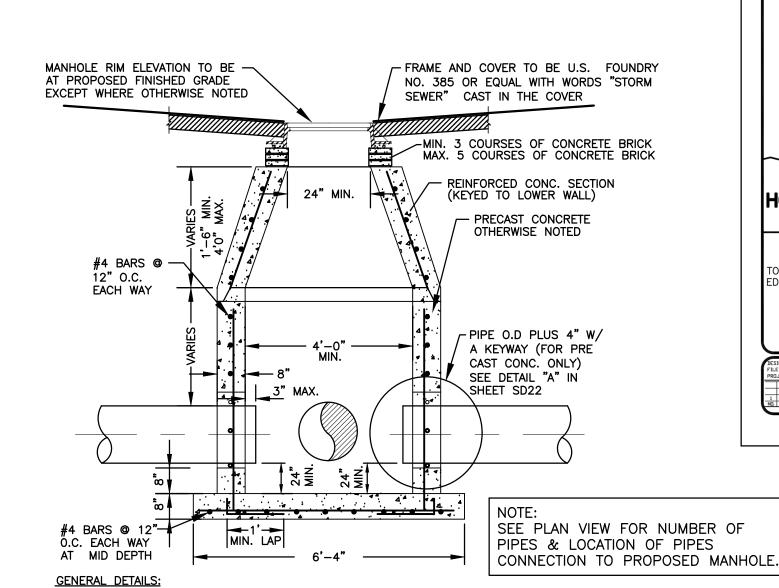

1. PROVIDE SHOP DRAWINGS OF STRUCTURES.

3 INCHES MINIMUM.

2. PRECAST CONCRETE MANHOLES SHALL CONFORM TO ASTM C478, SHALL BE TYPE II

4. ALL REINFORCING BARS SHALL BE ASTM A615 GRADE 60, ALL COVER SHALL BE

3. REFER TO FODT INDEX 200 FOR ADDITIONAL DETAILS AND SPECIFICATIONS.

5. ALL OPENINGS SHALL BE SEALED WITH ELASTROMETIC GROUT

NTS

(TYPE 3 CEMENT) SEE DETAIL "A", IN SHEET SD22.

ACID RESISTANT CEMENT AND SHALL MAINTAIN A MINIMUM COMPRESSIVE STRENGTH

CONCENTRIC PRECAST DRAINAGE MANHOLE (4'-0" MIN. DIA.) DETAIL

NO. 4155-6210 FIN. GRADE BRICK & MORTAR TO GRADE (2 COURSE MIN., 5 MAX.) 42"x42" MIN. DRAINAGE PIPE-SIZE VARIES, SEE PGD PLANS FOR PIPE SIZES 12" O.C. (TYP) & BASIN INV. W/ 18" HOOK ELEV. (TYP.) 3" (MIN) -#4 HOOPS @ 12" O.C. (TYP) - #4 BARS @ 12" O.C. PROVIDE 6" GRAVEL BED EACHWAY (TYP) (TYP., FOR EACH STRUCTURE) TYPICAL CATCH BASIN DETAIL

BASIN FRAME & GRATE (SEE DETAIL) ----

U.S. FOUNDRY & MFG. CORP. MODEL

SEE PLAN

1/4":1'-0"

— COMPACTED

NTS

— R.=1/2"


NEOPRENE

BAFFLE)

1-1/2" ASPHALT SURFACE

OVER LIMEROCK BASE (8"


SIDEWALK WITH CURB DETAIL

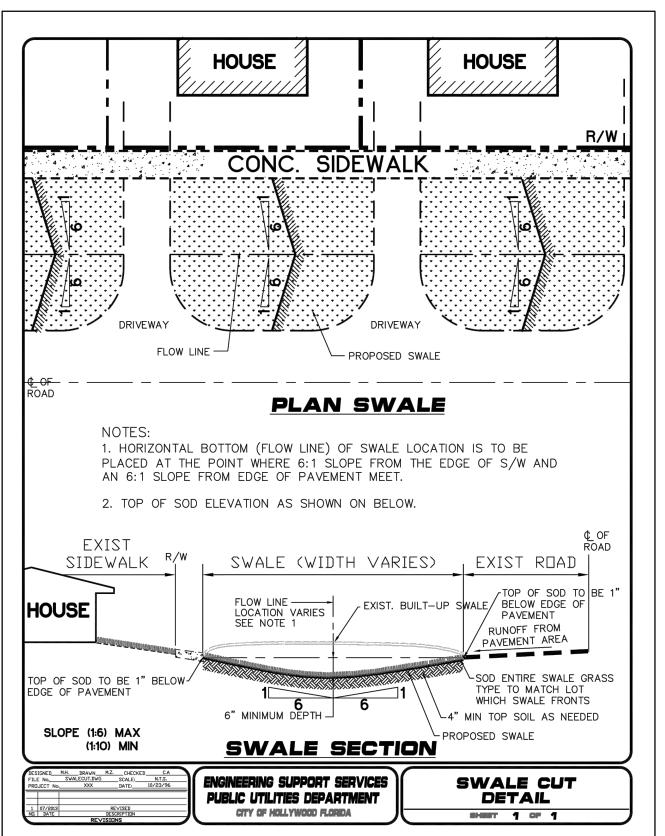


ALL ELEVATIONS ARE REFERENCED TO NAVD88 VERTICAL DATUM


GENERAL NOTES

1. BAFFLE TO BE SECTION OF CMP CUT IN HALF, CMP PIPE FOR BAFFLE SHALL BE THE NEXT LARGER PIPE SIZE THAN DISCHARGE LINE.

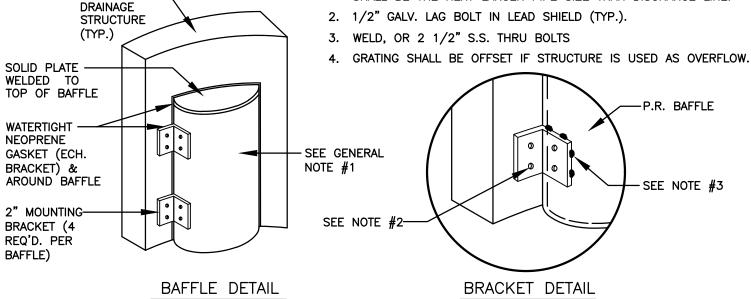

POLLUTION RETARDANT BAFFLE DETAIL

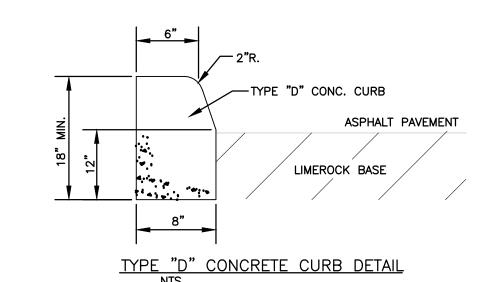

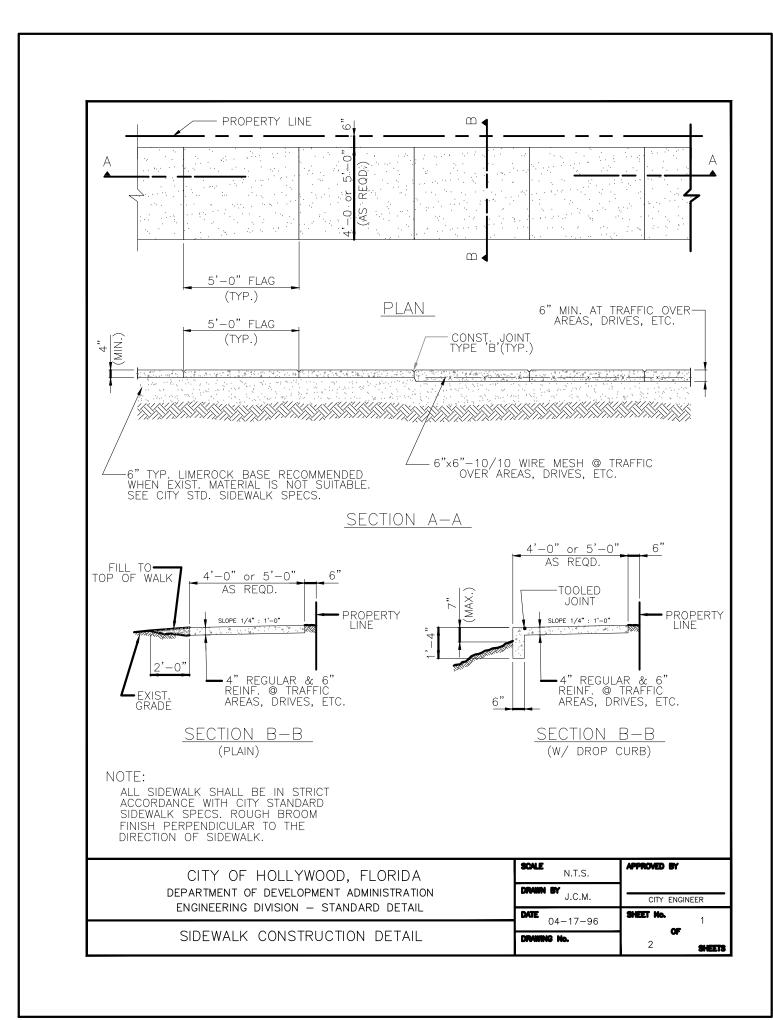

THIS ITEM HAS BEEN DIGITALLY SIGNED AND SEALED BY WILFORD ZEPHYR ON THE DATE ADJACENT TO THE SEAL.

PRINTED COPIES OF THIS DOCUMENT ARE NOT CONSIDERED SIGNED AND SEALED AND THE SIGNATURE MUST BE VERIFIED ON ANY ELECTRONIC COPIES.

No 76036 STATE OF 5-22-23

SCALE: N.T.S.

P.E.#:76036 DATE: 5/9/23


Ш

SCALE: N.T.S. SHEET NO .: 3 OF 10

田 る 5

PROJECT NO.: 23-15

CIVIL DETAILS

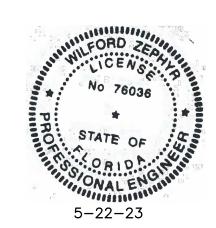

THIS ITEM HAS BEEN DIGITALLY SIGNED AND SEALED BY WILFORD ZEPHYR ON THE DATE ADJACENT TO THE SEAL.

PRINTED COPIES OF THIS DOCUMENT ARE NOT CONSIDERED SIGNED AND SEALED AND THE SIGNATURE MUST BE VERIFIED ON ANY ELECTRONIC COPIES.

P.E.#:76036

DATE: 5/22/23
SCALE: N.T.S.

SHEET NO.:

EERING


ZEPHY


APARTMENT STREET L 33020

ORE 2215 HOI

4 OF 10 PROJECT NO.: 23–15

CIVIL DETAILS II
SCALE: N.T.S.

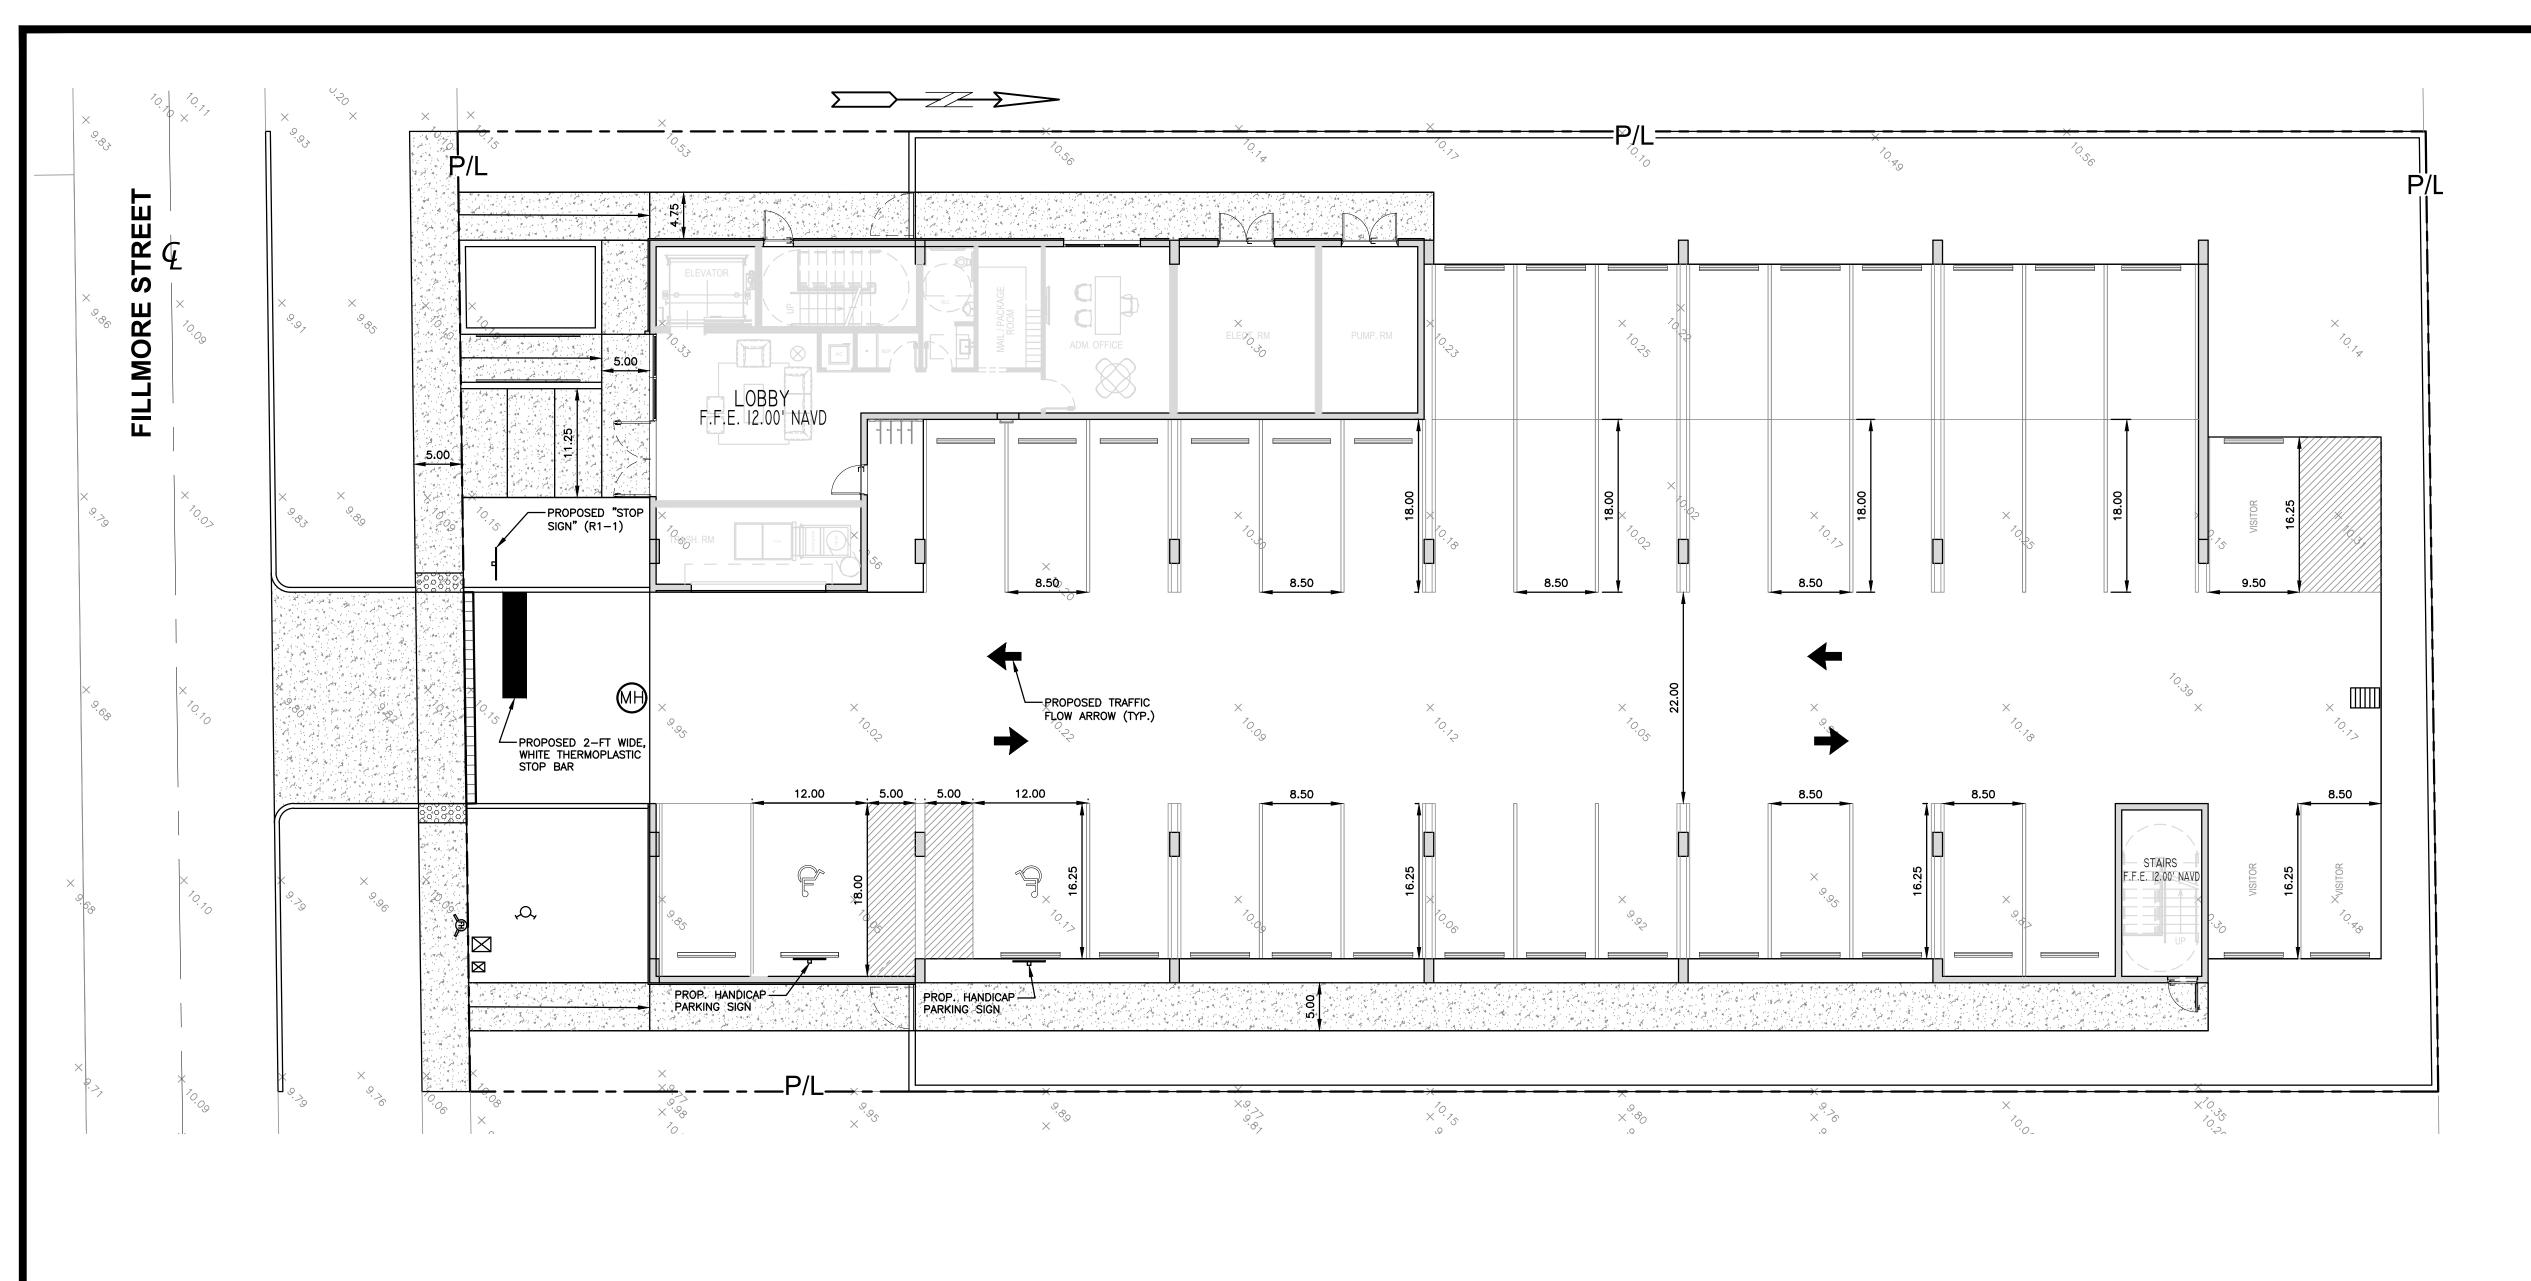

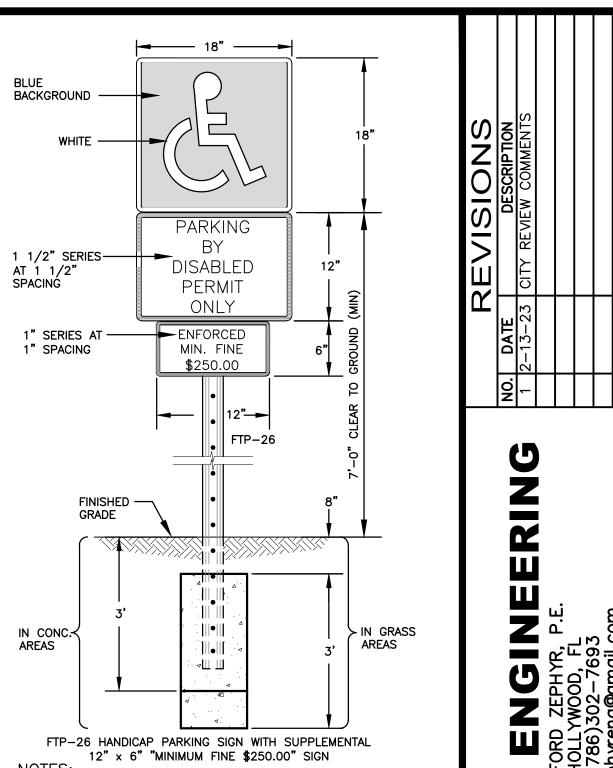



NOTES:

1. TOP PORTION OF SIGN SHALL HAVE A REFLECTORIZED BLUE BACKGROUND.

BOTTOM PORTION OF SIGN SHALL HAVE A REFLECTORIZED WHITE BACKGROUND WITH BLACK OPAQUE LEGEND AND BORDER.

 LOCATE SIGN AT CENTERLINE AND HEAD OF EACH HANDICAP PARKING STALL, WHERE APPLICABLE. HANDICAP PARKING SIGN DETAIL

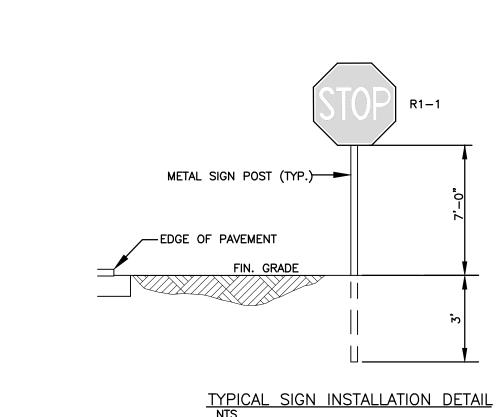

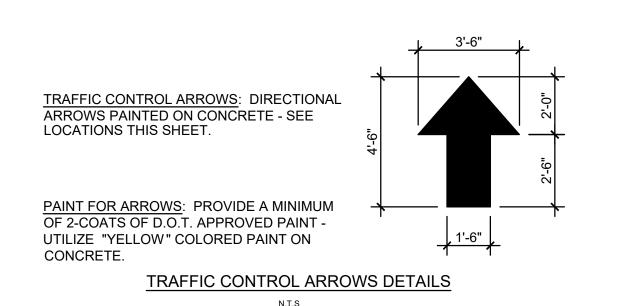




PROPOSED CONCRETE PROPOSED ASPHALT

8.90 PROPOSED GRADE EXISTING ELEVATION PROPOSED CATCH BASIN

EXISTING CATCH BASIN PROPOSED WATER METER EXISTING WATER METER

EXISTING WATER VALVE PROPOSED BFP DEVICE EXISTING SAN. SEWER MH EXISTING FIRE HYDRANT

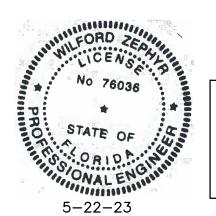

THIS ITEM HAS BEEN DIGITALLY SIGNED AND SEALED BY WILFORD ZEPHYR ON THE DATE ADJACENT TO THE SEAL.

PRINTED COPIES OF THIS DOCUMENT ARE NOT CONSIDERED SIGNED AND SEALED AND THE SIGNATURE MUST BE VERIFIED ON ANY ELECTRONIC COPIES.

PAVEMENT MARKINGS & SIGNAGE PLAN

SCALE: 1"=10'

P.E.#:76036

ZEPH

DATE: 5/9/23 SCALE: 1"=10'

SHEET NO.: 5 OF 10

PROJECT NO.: 23-15

TRAFFIC ENGINEERING DIVISION

DRAWN BY: STEPHON RAMOUTAR

F L O R I D A CHECKED BY: ANDREW SEBO, P.E., PTOE


DATE

01-15-2016

DESCRIPTION

UPDATED NOTES

06-11-2018 UPDATED FDOT INDEX REFERENCE

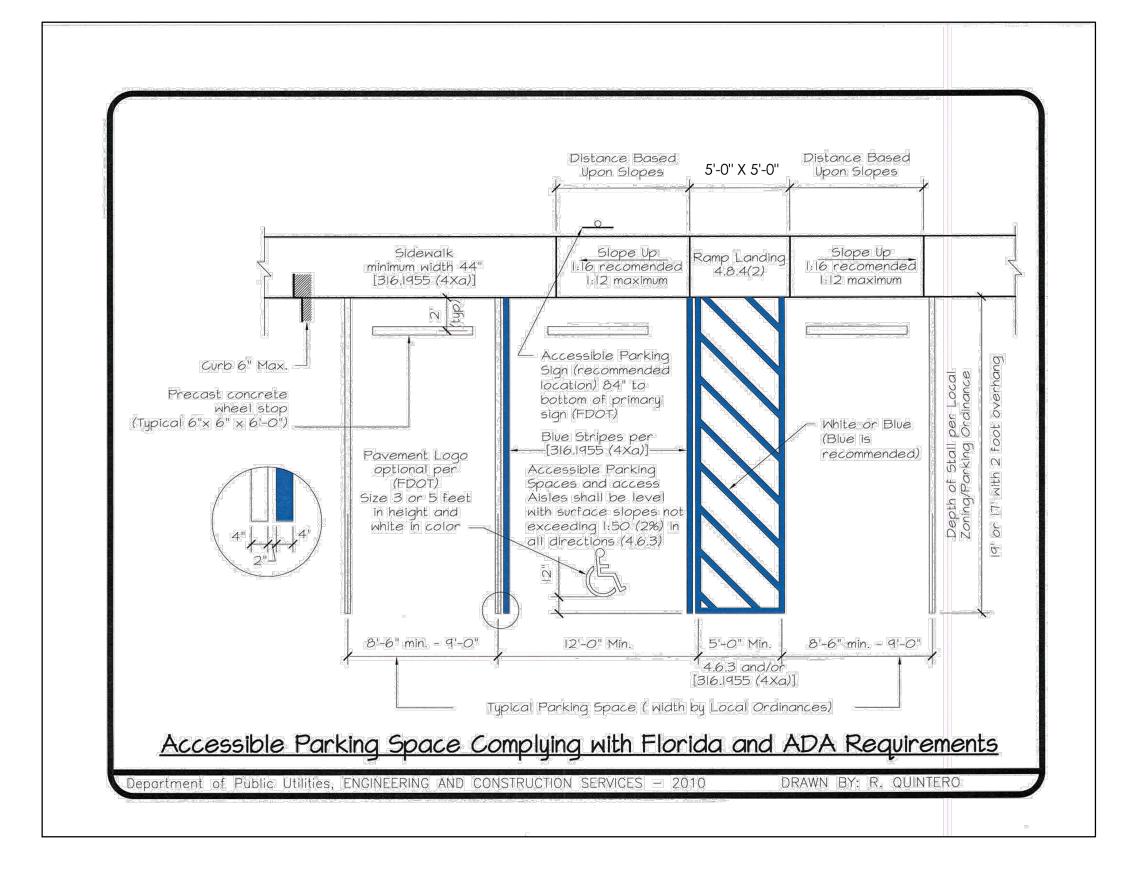

NO.

1 OF 1

AND SIGNS

DETAILS



5-22-23

THIS ITEM HAS BEEN DIGITALLY SIGNED AND SEALED BY WILFORD ZEPHYR ON THE DATE ADJACENT TO THE SEAL.

PRINTED COPIES OF THIS DOCUMENT ARE NOT CONSIDERED SIGNED AND SEALED AND THE SIGNATURE MUST BE VERIFIED ON ANY ELECTRONIC COPIES.

PAVEMENT MARKINGS DETAILS

SCALE: N.T.S.


INEERING R. P.E.

ZEPHY

ORE 2215 HOI

P.E.#:76036 DATE: 5/22/23 SCALE: N.T.S.

SHEET NO.: 6 OF 10 PROJECT NO.: 23-15

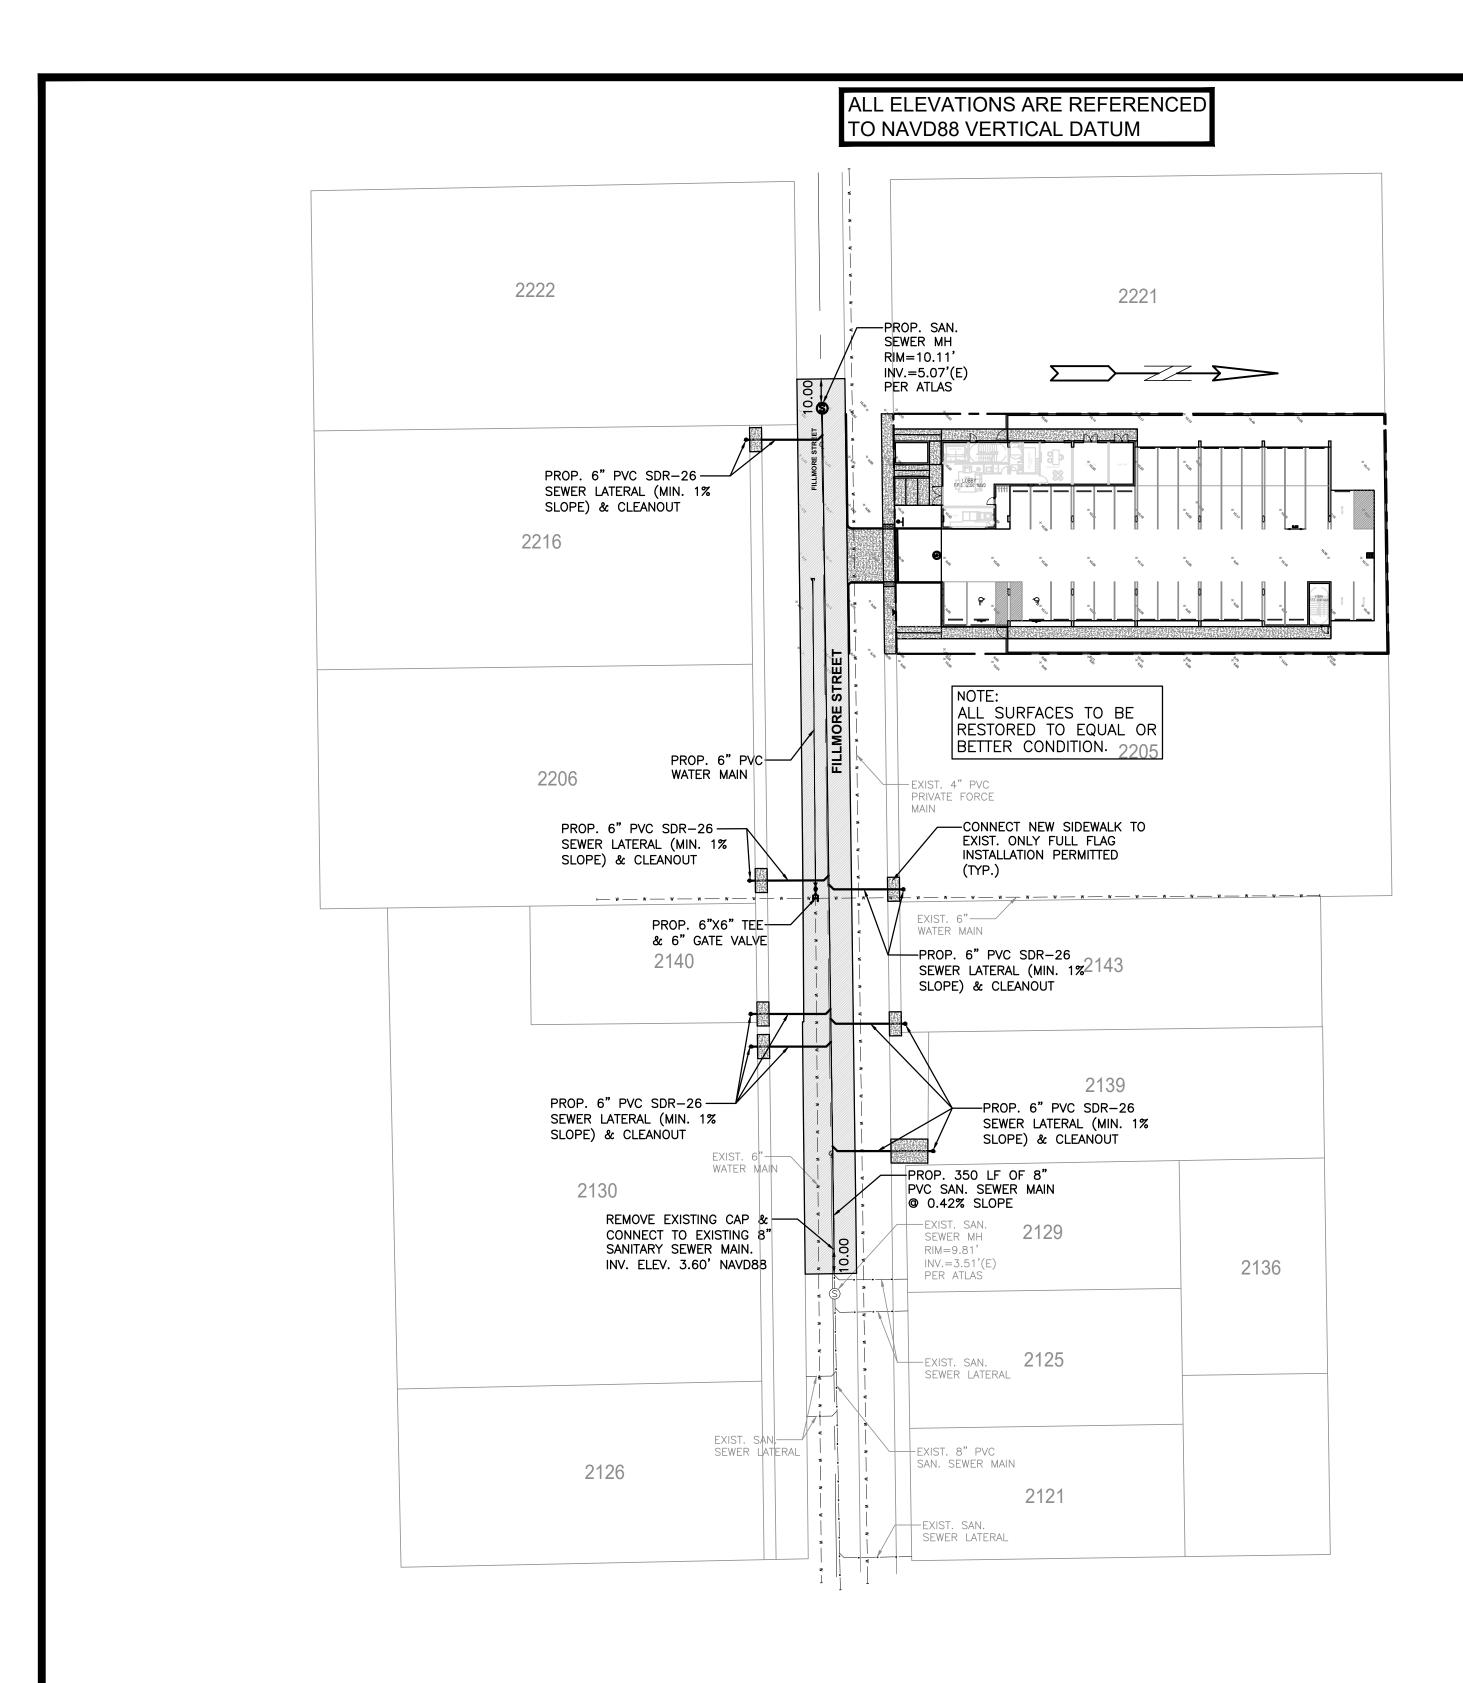

LEGEND

PROPOSED CONCRETE

PROPOSED ASPHALT

TILL PROPOSED CATCH BASIN

EXISTING CATCH BASIN

PROPOSED WATER METER

EXISTING WATER METER


EXISTING WATER VALVE


N PROPOSED BFP DEVICE


(S) EXISTING SAN. SEWER MH

EXISTING FIRE HYDRANT

8.90 PROPOSED GRADE +11.3 EXISTING ELEVATION

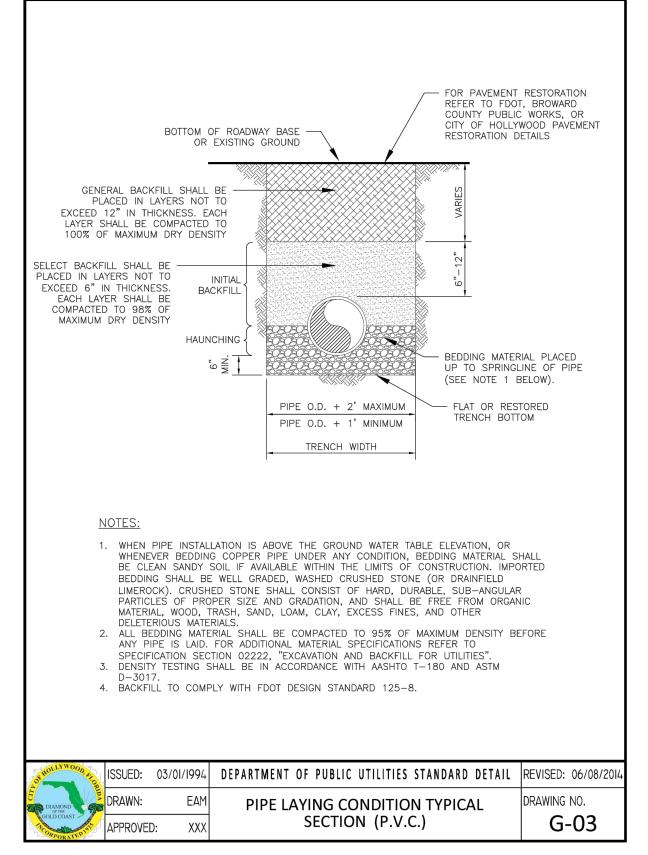

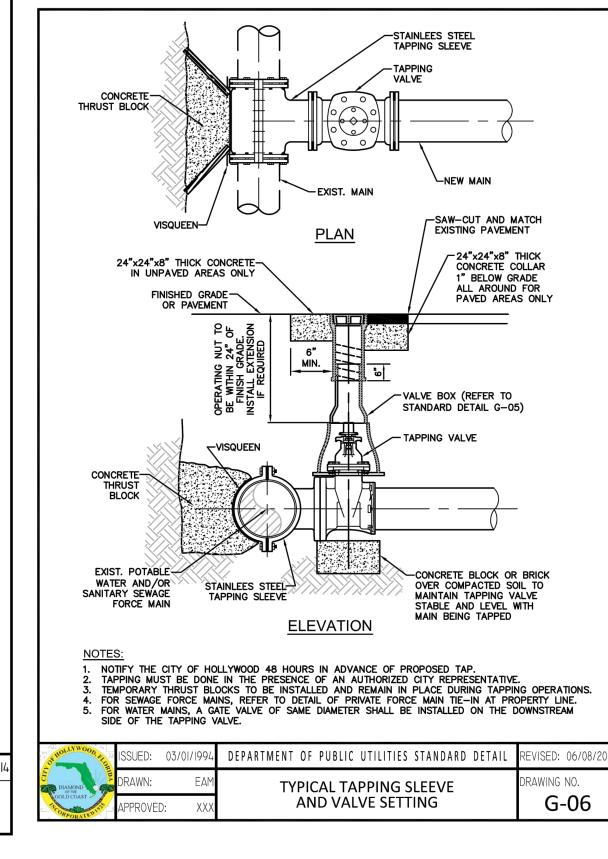

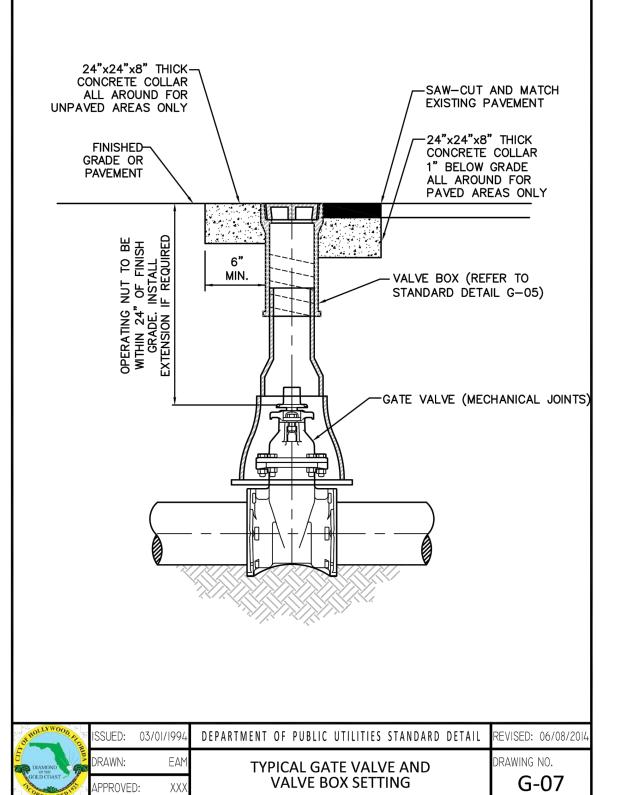

FLEXIBLE PAVEMENT RESTORATION NOTES:

- THE ABOVE DETAILS APPLY ONLY TO ASPHALT PAVEMENT RESTORATION OVER UTILITY TRENCHES CUT WITHIN CITY OF HOLLYWOOD RIGHTS-OF-WAY. FOR PAVEMENT RESTORATION WITHIN BROWARD COUNTY OR FDOT RIGHTS-OF-WAY REFER TO THE CORRESPONDING DETAILS FOR THOSE AGENCIES.
- LIMEROCK BASE MATERIAL SHALL HAVE A MINIMUM L.B.R. OF 100 AND A MINIMUM CARBONATE CONTENT OF 70%. REPLACED BASE MATERIAL OVER TRENCH SHALL BE A MINIMUM OF 12" THICK".
- LIMEROCK BASE MATERIAL SHALL BE PLACED IN 12" MAXIMUM (LOOSE MEASUREMENT) THICKNESS LAYERS WITH EACH LAYER THOROUGHLY ROLLED OR TAMPED AND COMPACTED TO 100% OF MAXIMUM DENSITY, PER AASHTO T-180, PRIOR TO THE PLACEMENT OF THE SUCCEEDING LAYERS.
- STABILIZED SUBGRADE MATERIAL SHALL BE GRANULAR AND SHALL HAVE A MINIMUM L.B.R. OF 40.
- BACKFILL SHALL BE PLACED AND COMPACTED IN ACCORDANCE WITH THE PIPE LAYING CONDITION TYPICAL SECTIONS IN DETAILS G-02 AND G-03, AND THE SPECIFICATIONS, BUT TESTING WILL BEGIN 12" ABOVE THE INSTALLED FACILITY.
- ALL EDGES AND JOINTS OF EXISTING ASPHALT PAVEMENT SHALL BE SAW CUT TO STRAIGHT LINES, PARALLEL TO OR PERPENDICULAR TO THE ROADWAY, PRIOR TO THE RESURFACING.
- RESURFACING MATERIAL SHALL BE FDOT SUPERPAVE, AND SHALL BE APPLIED A MINIMUM OF TWO INCH IN THICKNESS.
- MILL AND BUTT JOINT TO EXISTING PAVEMENT.
- IF THE TRENCH IS FILLED TEMPORARILY, IT SHALL BE COVERED WITH A 2" ASPHALTIC CONCRETE PATCH TO KEEP THE FILL MATERIAL FROM RAVELING UNTIL REPLACED WITH A PERMANENT PATCH.
- 10. REFER TO SPECIFICATIONS FOR DETAILED PROCEDURES.
- 11. WHERE THE UTILITY TRENCH CROSSES EXISTING ASPHALT DRIVEWAYS, THE LIMEROCK BASE THICKNESS MAY BE A MINIMUM OF 6 INCHES THICK. REGARDLESS OF THE EXTENT OF IMPACT, THE ENTIRE DRIVEWAY SURFACE BETWEEN THE EDGE OF THE ROADWAY PAVEMENT AND PROPERTY LINE OR FRONT OF SIDEWALK SHALL BE OVERLAID USING 2-INCH THICK MINIMUM ASPHALTIC CONCRETE SURFACE COURSE WHERE INDICATED ON THE PLANS OR AS DIRECTED BY THE CITY/ENGINEER.

OF HOLLYWOOD ATO	ISSUED:	03/01/1994	DEPARTMENT OF PUBLIC UTILITIES STANDARD DETAIL	REVISED: 11/06/2017
DIAMOND SO	DRAWN:	EAM	FLEXIBLE PAVEMENT RESTORATION	DRAWING NO.
GOLD COAST	APPROVE	D: XXX	NOTES	G-12



THIS ITEM HAS BEEN DIGITALLY SIGNED AND SEALED BY WILFORD ZEPHYR ON THE DATE ADJACENT TO THE SEAL.

PRINTED COPIES OF THIS DOCUMENT ARE NOT CONSIDERED SIGNED AND SEALED AND THE SIGNATURE MUST BE VERIFIED ON ANY ELECTRONIC COPIES.

SEWER EXTENSION PLAN & DETAILS

SCALE: 1"=40'

P.E.#:76036


DATE: 5/9/23 SCALE: 1"=40' SHEET NO.:

7 OF 10 PROJECT NO.: 23-15

ШР

NEERING P.E.

ORE 2215 HOI

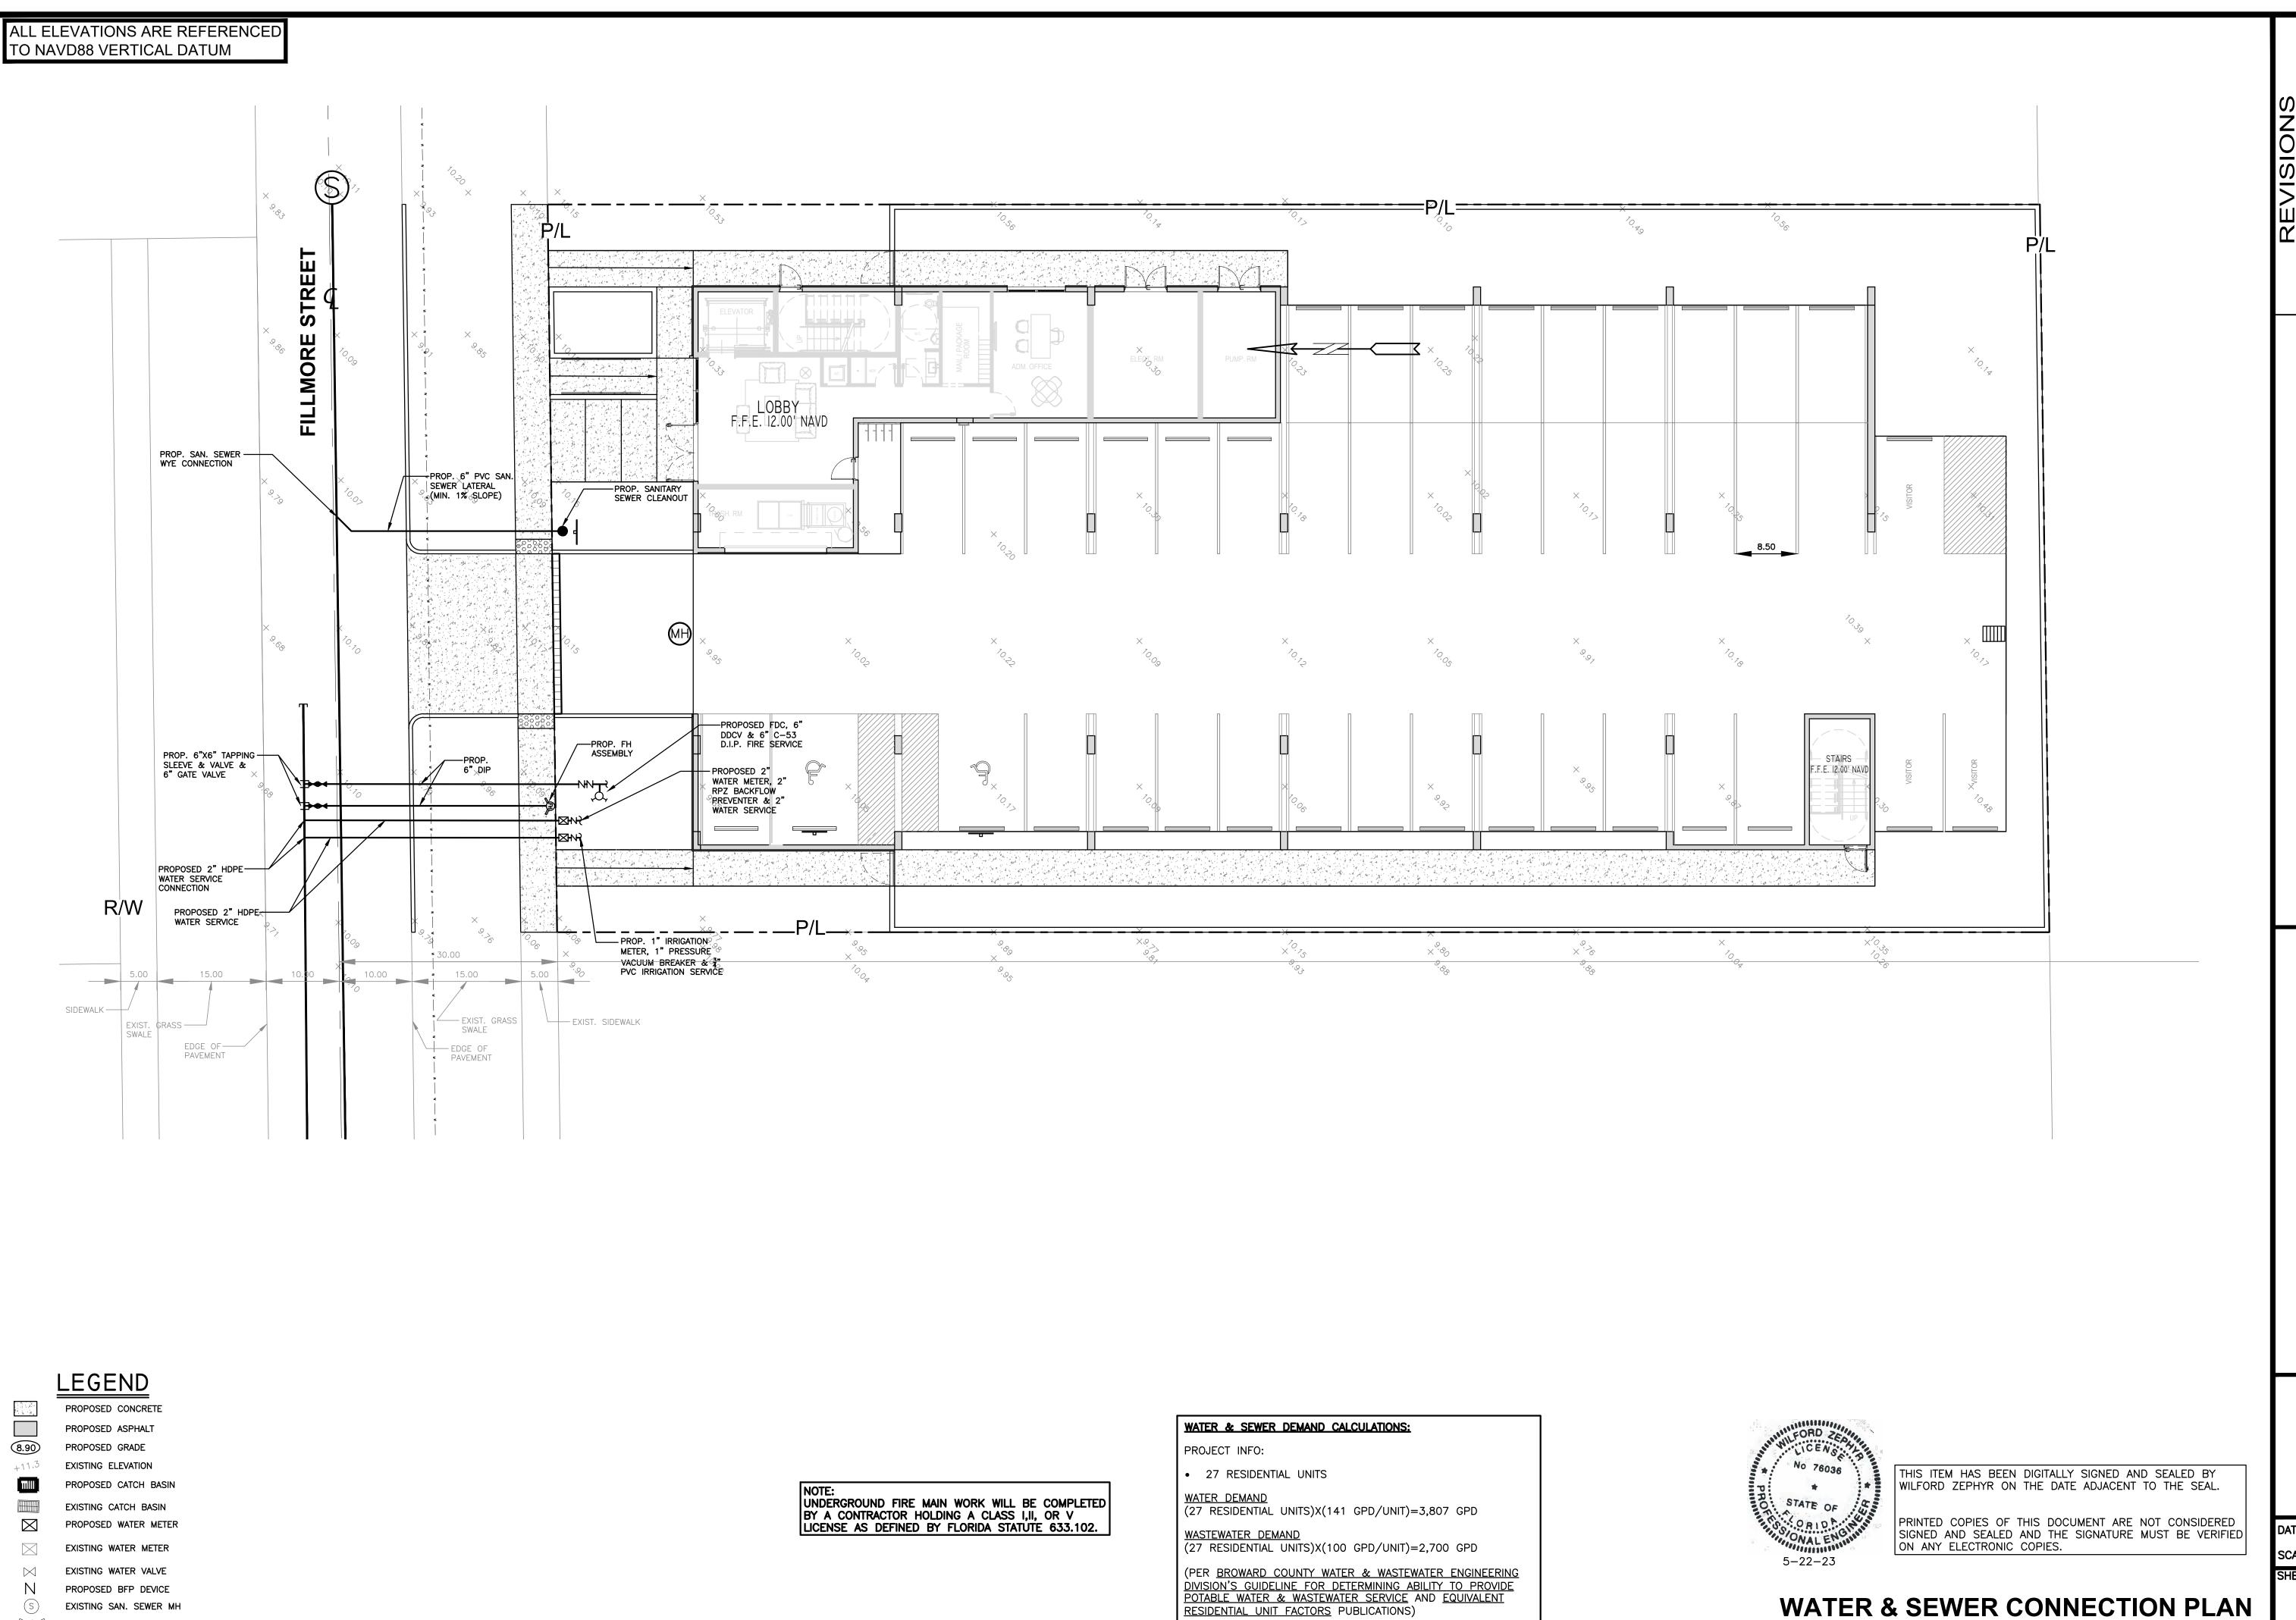

RESIDENTIAL UNIT FACTORS PUBLICATIONS)

EXISTING SAN. SEWER MH

EXISTING FIRE HYDRANT

ENGINEERING DRD ZEPHYR, P.E. ZEPHY

ORE 2215 HOI


P.E.#:76036

DATE: 5/9/23 SCALE: 1"=10'

8 OF 10

PROJECT NO.: 23-15

SCALE: 1"=10'

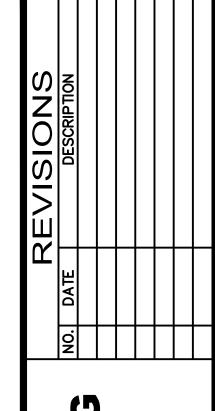

INEERING MR, P.E.


ZEPHY


STREET APARTMEN FILLMORE STREET LLYWOOD, FL 33020 ORE 2215 HOI

P.E.#:76036

DATE: 5/9/23 SCALE: N.T.S.

SHEET NO.: 9 OF 10 PROJECT NO.: 23-15

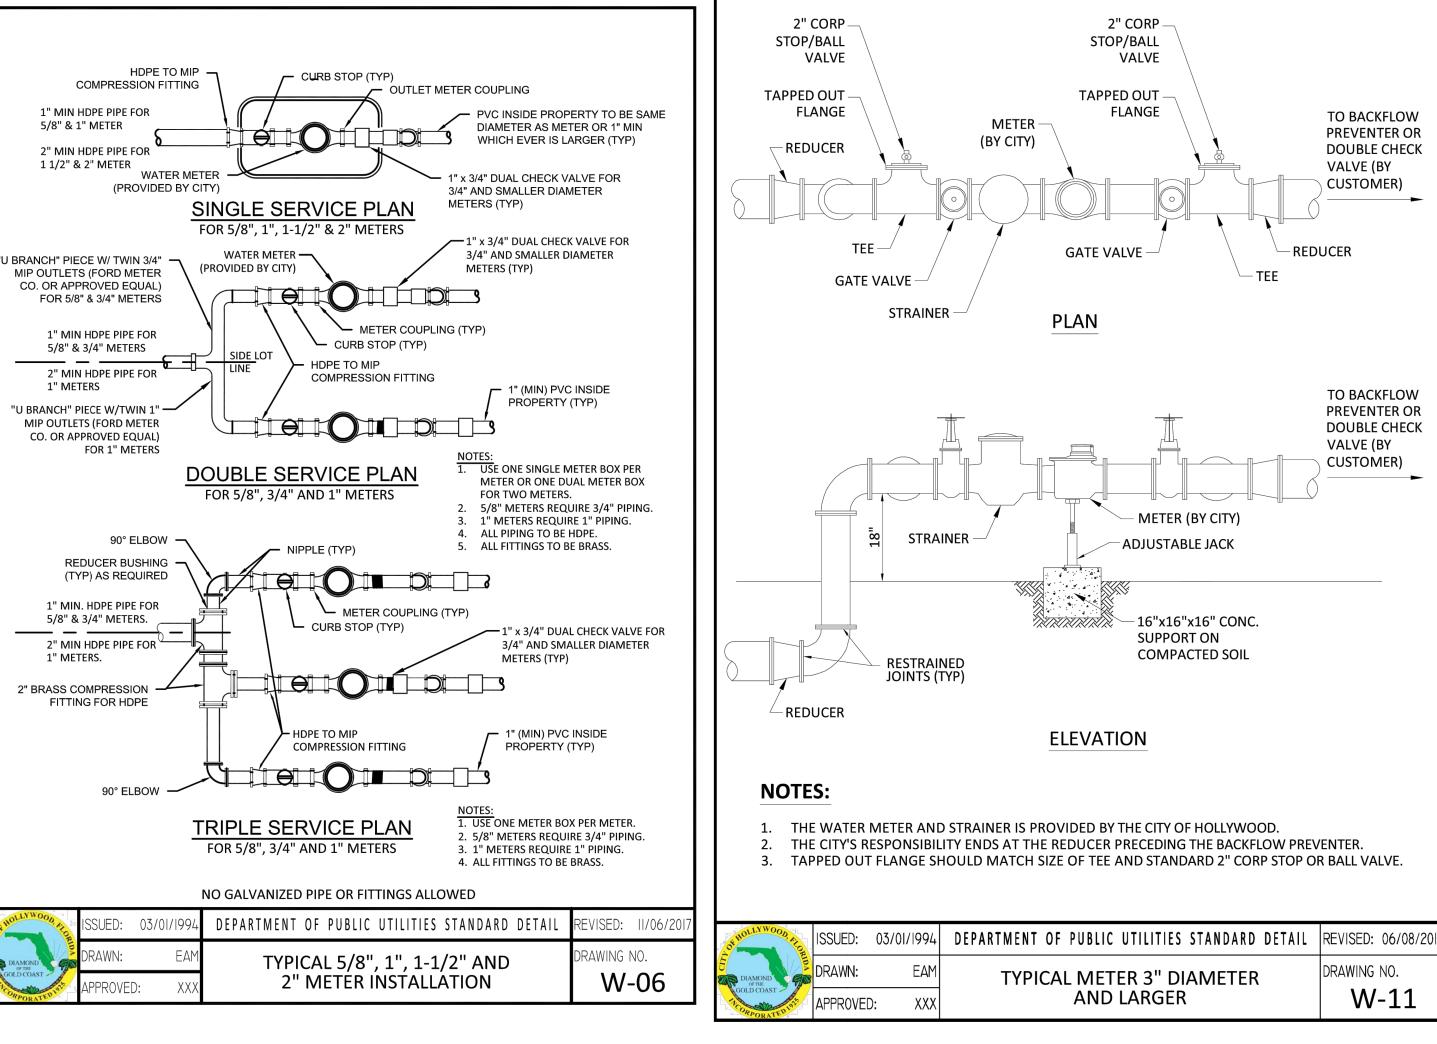

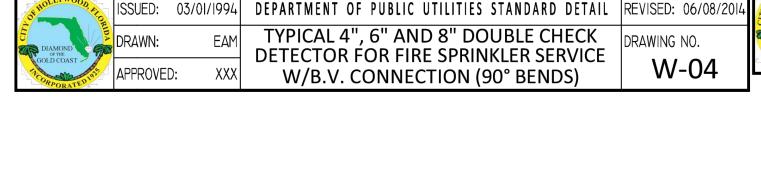

4. PROTECTIVE 4" GALV. GUARD POSTS SHALL BE SPACED EVENLY APART AS SHOWN ABOVE OR IN ACCORDANCE WITH

5. MAY USE 45° BENDS (SEE DETAIL W-05) WHEN WORKING AREA IS NOT LIMITED, AS DIRECTED BY CITY.

- 16"X16"X16"

SUPPORT

ITEM | QTY. | DESCRIPTION

14 1 4", 6", 8" CAP

1 4", 6", 8" TEE

8 N/A PLASTIC LINER/WEED STOP (5 MILS)

LOW FLOW METER

VALVE, BYPASS DOUBLE CHECK

CLOSED), CHAINED AND LOCKED

4", 6" 8" BUTTERFLY VALVE (SUPERVISED

CONC.

ELEVATION

MATERIALS

— P.T. 2"x4" LUMBER

FOR RETAINING

ROCK (ALL

AROUND)

-4" GUARD POST (SEE

NOTE 4 BELOW AND

ITEM QTY. DESCRIPTION

NOTES:

1 4",6",8" VALVE,DOUBLE CHECK

4",6",8" BEND-90°

10 4",6",8" FLANGE, D.I.P.

6 1 SCREW JACK/ANCHORED

7 N/A PEA GRAVEL (4" DEEP)

INSPECTOR'S DIRECTIONS.

4",6",8" D.I.P. SPOOL PIECE

1. FIELD ADJUST AND CUT ITEM 3 TO THE PROPER LENGTH.

. ALL LOW FLOW METER PIPING SHALL BE BRASS OR COPPER.


4",6",8" D.I.P. SPOOL PIECE(24" LONG)

2 4",6",8" GATE VALVE (SEE NOTE 6) 13 1

2. ALL PIPING SHALL BE D.I.P. CL 50/52 AS APPLICABLE TO MINIMUM STANDARDS.

6. GATE VALVES SHALL BE CHAINED AND LOCKED TOGETHER TO PREVENT TAMPERING

DETAIL ON SHEET W-03)

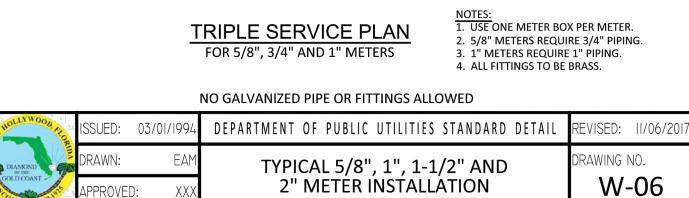



THIS ITEM HAS BEEN DIGITALLY SIGNED AND SEALED BY WILFORD ZEPHYR ON THE DATE ADJACENT TO THE SEAL.

PRINTED COPIES OF THIS DOCUMENT ARE NOT CONSIDERED SIGNED AND SEALED AND THE SIGNATURE MUST BE VERIFIED ON ANY ELECTRONIC COPIES.

UTILITIES DETAILS I

SCALE: N.T.S.

TO BACKFLOW

PREVENTER OR

DOUBLE CHECK

TO BACKFLOW

PREVENTER OR

DOUBLE CHECK

VALVE (BY

CUSTOMER)

DRAWING NO.

W-11

VALVE (BY

CUSTOMER)

- REDUCER

SEWER NOTES:

- 1. THE MINIMUM DEPTH OF COVER OVER D.I.P. SANITARY SEWER GRAVITY OR FORCE MAINS IS 30". THE MINIMUM DEPTH OF COVER OVER PVC SANITARY SEWER OR FORCE MAINS IS 36".
- 2. ALL CONNECTIONS TO EXISTING MAINS SHALL BE THE RESPONSIBILITY OF THE CONTRACTOR.
- 3. LEAKAGE TESTS AND ALIGNMENT (LAMPING) TESTS SHALL BE PERFORMED ON ALL NEW SEWER LINES UP TO THE CONNECTION POINT WITH THE EXISTING SEWER SYSTEM. THESE TESTS SHALL BE REQUESTED AND PAID FOR BY THE
- 4. LAMPING TESTS SHALL BE PERFORMED ON GRAVITY SEWERS FROM MANHOLE TO MANHOLE UP TO AND INCLUDING THE POINT OF CONNECTION TO THE EXISTING SEWER SYSTEM.
- 5. LEAKAGE TESTS SHALL BE PERFORMED ON ALL SEGMENTS OF A GRAVITY SEWER SYSTEM, INCLUDING SERVICE LATERALS AND MANHOLES, FOR A CONTINUOUS PERIOD OF NO LESS THAN 2 HOURS. AT THE END OF THE TEST, THE TOTAL MEASURED LEAKAGE SHALL NOT EXCEED 100 GALLONS PER INCH OF PIPE DIAMETER PER MILE PER DAY FOR ANY SECTION OF THE SYSTEM, WITH ZERO ALLOWABLE LEAKAGE FOR LATERALS AND MANHOLES. AN EXFILTRATION OR INFILTRATION TEST SHALL BE PERFORMED WITH A MINIMUM POSITIVE HEAD OF 2 FEET ON THE SECTION BEING
- 6. FORCE MAINS SHALL BE PRESSURE-TESTED IN ACCORDANCE WITH RULE 62-555.330 (FAC). THE PRESSURE TEST SHALL CONSIST OF HOLDING A TEST PRESSURE OF 150 PSI ON THE PIPELINE FOR A CONTINUOUS PERIOD OF 2 HOURS THE MAXIMUM ALLOWABLE LEAKAGE SHALL BE DETERMINED BY THE FOLLOWING FORMULA:


$L = S \times D \times \sqrt{P}$

- L = ALLOWABLE LEAKAGE FOR SYSTEM IN GALLONS PER HOUR
- D = PIPE DIAMETER IN INCHES
- S = LENGTH OF LINES IN LINEAL FEET P = AVERAGE TEST PRESSURE IN PSI
- 7. CONTRACTOR SHALL BE RESPONSIBLE FOR IDENTYFYING CONFLICTS WITH FORCE MAINS PLACED AT MINIMUM COVER. IN CASE OF CONFLICT, FORCE MAIN SHALL BE LOWERED TO PASS UNDER CONFLICTS WITH 12" MINIMUM SEPARATION FROM WATER MAINS AND 6" MINIMUM SEPARATION FROM OTHER UTILITIES. NO ADDITIONAL PAYMENT SHALL BE DUE TO CONTRACTOR FOR LOWERING THE MAIN OR THE ADDITIONAL FITTINGS USED THEREON.
- 8. WHENEVER IT IS NECESSARY, IN THE INTEREST OF SAFETY, TO BRACE THE SIDES OF A TRENCH, THE CONTRACTOR SHALL FURNISH, PUT IN PLACE AND MAINTAIN SUCH SHEETING OR BRACING AS MAY BE NECESSARY TO SUPPORT THE SIDES OF THE EXCAVATION TO ENSURE PERSONNEL SAFETY, AND TO PREVENT MOVEMENT WHICH CAN IN ANY WAY DAMAGE THE WORK OR ENDANGER ADJACENT STRUCTURES. THE CONTRACTOR SHALL BE SOLELY RESPONSIBLE FOR THE SEQUENCE, METHODS AND MEANS OF CONSTRUCTION, AND FOR THE IMPLEMENTATION OF ALL OSHA AND OTHER SAFETY REQUIREMENTS.

SSUED: 03/01/1994 DEPARTMENT OF PUBLIC UTILITIES STANDARD DETAIL REVISED: 06/08/201


SANITARY SEWER MAIN CONSTRUCTION NOTES

DRAWING NO.

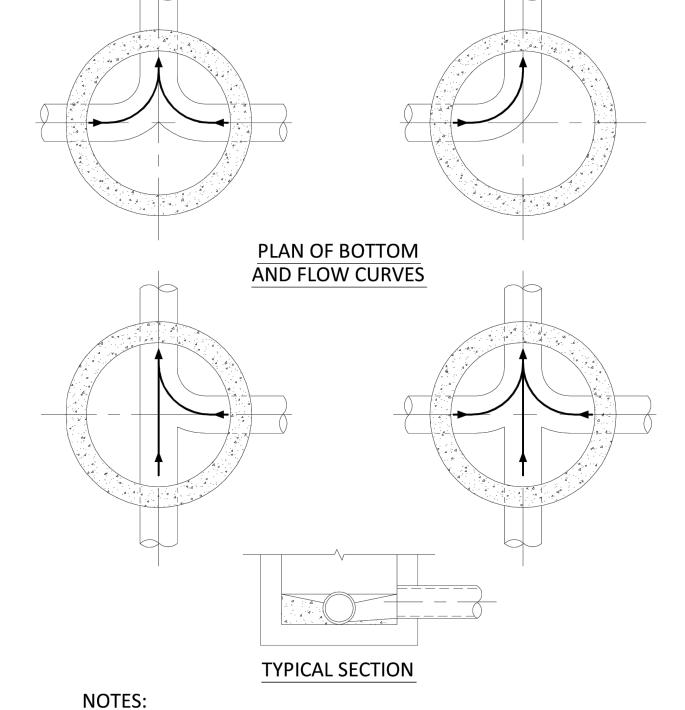

- 1. INVERT CHANNELS TO BE CONSTRUCTED FOR SMOOTH FLOW WITH NO
- OBSTRUCTIONS. 2. SPILLWAYS SHALL BE CONSTRUCTED BETWEEN PIPES WITH DIFFERENT INVERT
- ELEVATIONS PROVIDING SMOOTH FLOWS. 3. CHANNELS FOR FUTURE CONNECTIONS (STUBS) SHALL BE CONSTRUCTED FILLED WITH
- SAND & COVERED WITH 1" OF MORTAR. 4. WHEN FLOW LINE DEFLECTS MORE THAN 45°, A DROP OF 0.10' IS REQUIRED.

OF HOLLYWOOD, ALOR	ISSUED:	03/01/1994	DEPARTMENT OF PUBLIC UTILITIES STANDARD DETAIL	REVISED: 06/08/201
DIAMOND OF THE GOLD COAST	DRAWN:	EAM	MANHOLE FLOW PATTERNS	DRAWING NO.
	APPROVED:	: XXX	MANHOLE FLOW PATTERINS	S-02

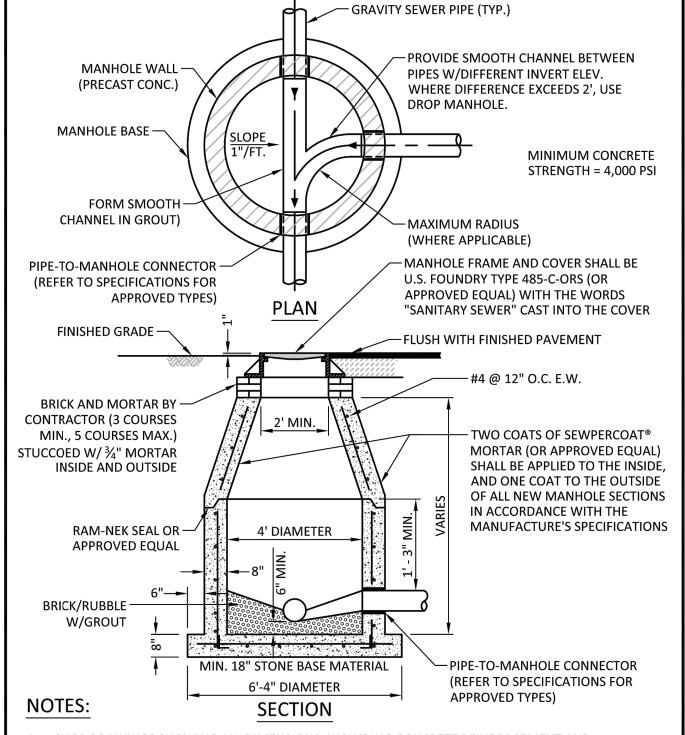

SHOP DRAWINGS SHOWING ALL DIMENSIONS, INCLUDING CONCRETE REINFORCEMENT AND BUOYANCY, SHALL BE SUBMITTED TO THE CITY PRIOR TO INSTALLATION.

THE BOTTOM SLAB SHALL BE CAST MONOLITHICALLY WITH THE LOWER WALL SECTION TO A MINIMUM OF 3' ABOVE SLAB BASE.


- 6" SERVICE , PIPE

NO CONSTRUCTION JOINTS ARE ALLOWED BELOW ELEVATION +2.00 NAVD. ABOVE ELEVATION +2.00 NAVD CONSTRUCTION JOINTS ARE ALLOWED, IF ADEQUATE JOINTS WITH KEY-WAYS AND WATER STOPS

ARE PRO	ARE PROVIDED. SUBMIT SHOP DRAWINGS OF JOINT DETAILS TO THE ENGINEER FOR APPROVAL.					
HOLLYWOOD	ISSUED:	03/01/1994	DEPARTMENT OF PUBLIC UTILITIES STANDARD DETAIL	REVISED: 07/18/2018		
DIAMOND OF THE	DRAWN:	EAM	STANDARD PRECAST MANHOLE	DRAWING NO.		
GOLD COAST	APPROVED): XXX	STAINDAND PRECAST IVIAINHOLE	S-03		

18" SQUARE

SCREW PLUG

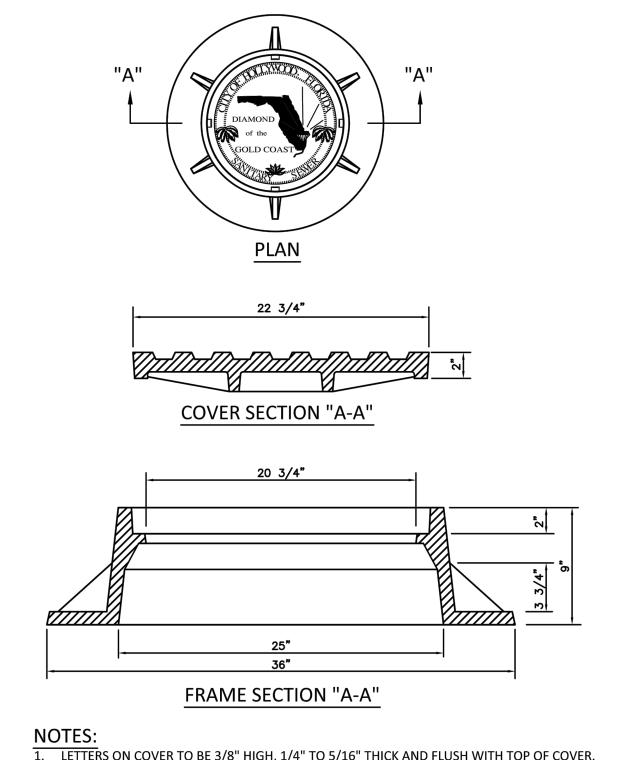


- LETTERS ON COVER TO BE 3/8" HIGH, 1/4" TO 5/16" THICK AND FLUSH WITH TOP OF COVER.
- 2. ALL BEARING SURFACES TO BE MACHINED. 3. MINIMUM WEIGHTS: COVER - 160 LBS., TOTAL - 400 LBS.

4. MANHOLE FRAME AND COVER SHALL BE U.S. FOUNDRY 485-C-ORS TYPE EL, WITH THE WORDS "SANITARY SEWER" CAST INTO THE COVER.

ISSUED: 03/01/1994	DEPARTMENT OF PUBLIC UTILITIES STANDARD DETAIL	REVISED: 06/08/2014
DRAWN: EAM	MANHOLE FRAME AND COVER	DRAWING NO.
APPROVED: XXX	CITY OF HOLLYWOOD	S-06.1

Ш

PRINTED COPIES OF THIS DOCUMENT ARE NOT CONSIDERED SIGNED AND SEALED AND THE SIGNATURE MUST BE VERIFIED

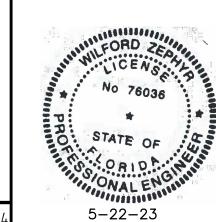


THIS ITEM HAS BEEN DIGITALLY SIGNED AND SEALED BY WILFORD ZEPHYR ON THE DATE ADJACENT TO THE SEAL.

ON ANY ELECTRONIC COPIES.

UTILITIES DETAILS II SCALE: N.T.S.


NEW SEWER MAIN ROTATE BEND AS REQUIRED TO ALIGN	
ROTATE BEND AS REQUIRED TO ALIGN	
SERVICE BRANCH WITH SERVICE PIPE	
S N	SEE IOTE (
WYE BRANCH WYE BRANCH	
MISSION, FERNCO OR EQUAL FLEXIBLE COUPLING WITH STAINLESS STEEL BANDS	
<u>PLAN</u>	
— ALTERNATE ADDITIONAL RISE AND BEND WHERE REQUIRED BY GREATER SEWER DEPTH	

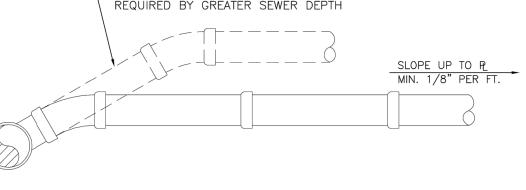

ELEVATION

- SINGLE SERVICE CONNECTIONS SHALL USE 6" PIPE AND FITTINGS.
- USE RISER CONNECTIONS WHERE INVERT OF SEWER IS GREATER THAN 7'-0" DEEP. 3. WHERE BELL OF WYE AND SPIGOT OF EXISTING MAIN ARE NOT COMPATIBLE, USE A SECOND FLEXIBLE COUPLING.

OF HOLLYWOOD, PETO	ISSUED:	03/01/1994	DEPARTMENT OF PUBLIC UTILITIES STANDARD DETAIL	REVISED: 06/08/2014	
DIAMOND OF THE	DRAWN:	EAM	WYE BRANCH CONNECTION	DRAWING NO.	
GOLD COAST	APPROVED): XXX	WYE BRANCH CONNECTION	S-09	

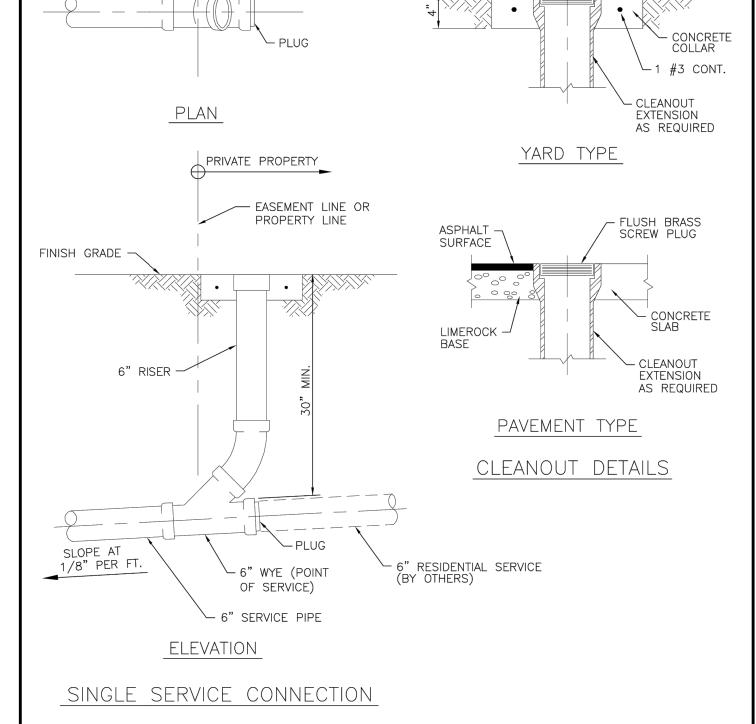

DLLYWOOD, FELOR	ISSUED:	03/01/1994	DEPARTMENT OF PUBLIC UTILITIES STANDARD DETAIL	REVISED: 06/08/2014
DIAMOND OF THE	DRAWN:	EAM	SEWER SERVICE CONNECTION AND	DRAWING NO.
ORPORATED 1975	APPROVED: XXX		CLEANOUT AT PROPERTY LINE	S-12

P.E.#:76036 DATE: 5/9/23 SCALE: N.T.S. SHEET NO .:

10 OF 10 PROJECT NO.: 23-15 General site and berm grading to +/- 1 inch (1") shall be provided by the general contractor. All finished site grading and final decorative berm shaping shall be provided by the landscape contractor.

All sizes shown for plant material on the plans are to be considered Minimum. All plant material must meet or exceed these minimum requirements for both height and spread. Any other requirements for specific shape or effect as noted on the plan(s) will also be required for final acceptance.

All plant material furnished by the landscape contractor shall be Florida #1 or better as established by Grades and Standards for Florida Nursery Trees and Plants.

All trees designated as single trunk shall have a single, relatively straight, dominant leader, proper structural branching and even branch distribution. Trees with bark inclusion, tipped branches, and co—dominant trunks will not be accepted. Trees with girdling, circling and/or plunging roots will be rejected.

All planting beds shall be free of all rocks $\frac{1}{2}$ " or larger, sticks, and objectionable material including weeds, weed seeds. All limerock shall be removed/cleaned down to the native soils. Planting soil 50/50 sand/topsoil mix shall be delivered to the site in a clean loose and friable condition and is required around the root ball of all trees and palms, the top 6" of all shrubs and ground cover beds. This soil can be tilled into the existing soil after the existing soil has been cleaned of all rocks, limestone and sticks. Recycled compost is encouraged as a soil amendment alternative. Sod 1.5-2" topsoil comes furnished.

All burlap, string, cords, wire baskets, plastic or metal containers shall be removed from the rootballs before planting. Remove all bamboo and metal nursery stakes. Remove all tagging tape.

All trees/palms shall be planted so the top of the root ball, root flair are slightly above final grade. Shrub material shall be planted such that the top of the plant ball is flush with the surrounding grade. It is the sole responsibility of the landscape contractor to insure that all new plantings receive adequate water during the installation and during all plant warranty periods. Deep watering of all new trees and palms and any supplemental watering that may be required to augment natural rainfall and site irrigation is mandatory to insure proper plant development and shall be provided as a part of this contract.

All trees/palms shall be staked using biodegradable material. No wire, black strapping, or other synthetic material shall be used. Nailing into trees and palms for any reason is prohibited and the material will be rejected. Please refer to the planting details

All landscape areas shall be irrigated by a fully automatic sprinkler system with a minimum 100% coverage with all heads adjusted to 50% overlap. Each system shall be installed with an operational rain sensor and rust inhibitor.

No fertilizers are required.

approval.

All landscape areas shall be covered with Pine Straw, Pine Bark, Eucalyptus or sterilized seed free Melaleuca mulch to a minimum depth of two inches (2") of cover when settled. Spread mulch to 1" thickness 3" away from the trunks/stems of all plant material. All trees in sodded areas shall have a clean cut 4' diameter mulch ring. The 5-6" height water ring shall be made from mulch, not soil. Certain areas may receive a thicker mulch cover where noted on plans. Cypress, red, gold and green mulch is prohibited.

Please refer to the planting details for a graphic representation of the above

All plant material shall be warranted by the landscape contractor for One Year after Final Inspection.

Trees and Palms shall not be removed without first obtaining an approved Tree Removal Permit from the City of Hollywood.

No landscape substitutions shall be made without the City of Hollywood


Banding Wire Around
5 Layers Burlap (Min.)

2x4" Wood Battens
Do Not Nail Wood Battens
Into Trunk

2x4" Wood Braces Nailed
Into the Wood Battens


3" Mulch Layer

TREE/PALM BRACING DETAIL

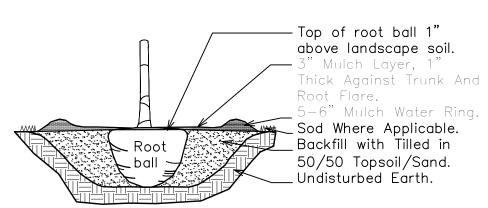


TREE/PALM PLANTING DETAIL

SOD INSTALLATION DETAIL
NTS

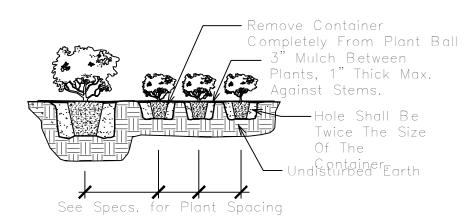


SHRUB PLANTING DETAIL

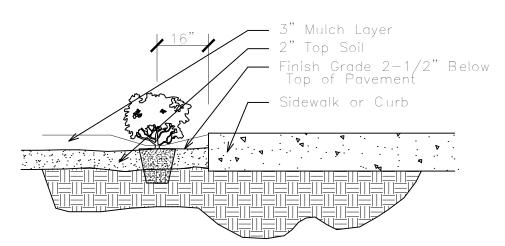


SHRUB INSTALLATION DETAIL



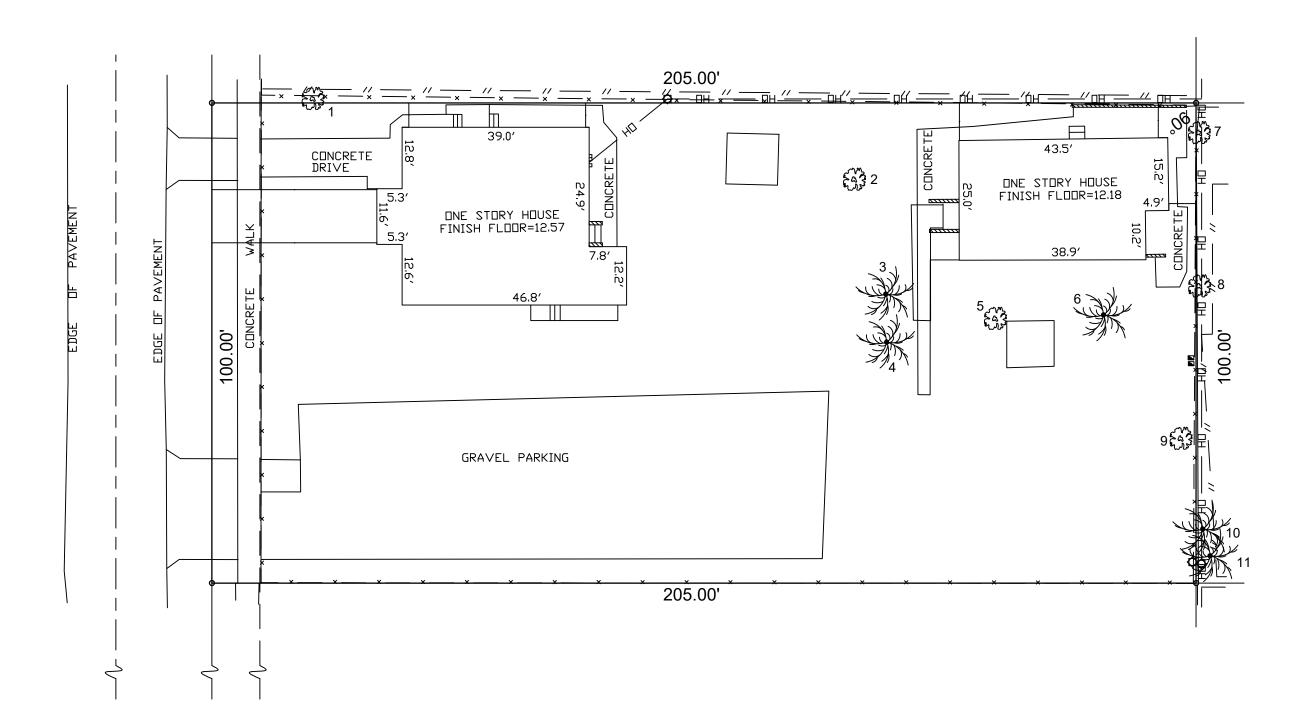

Case/Location	: 2215 Fillmore Street, Hollywood, FL						
Date	5/20/2023						
Appraiser	Thomas White, ASLA-ISA. Arborist FL-5	5248A					
Tree	Species	Ht.	Spr.	DBH	Condition	DBH	Disposition
#	Botanical Name / Common Name	(Feet)	(Feet)	(Inches)		Removed	
	·		,	,		(Inches)	
1	Ficus microcarpa / Indian Laurel	20	30	24	Fair-Poor	24	Remove
2	Bischofia javanica / Bishopwood	25	25	18	Poor	0	Remove
5	Persea americana / Avocado	20	8	17	Near Dead	17	Remove
7 **	Bursera simarubra / Gumbo Limbo	20	10	16	Very-Very Poor	16	Remove
8 **	Quercus virginiana / Live Oak	16	8	8	Very-Very Poor	8	Remove
					DBH Removed	65	
**	Hat racked from utility line clearance trimming						
Existing Pa	alm List						
	Article 9.9.B.3.c. per City of Hollywood	•		e highly susc	eptible to lethal		
	vellowing (per UF-IFAS) = Cocos nuci						
Palm	yellowing (per UF-IFAS) = Cocos nuci Species	177		DBH	Condition	Replacement	Disposition
Palm #	yellowing (per UF-IFAS) = Cocos nuci Species Botanical Name / Common Name	Ht. (Feet)	CT (Feet)	DBH (Inches)	Condition	Replacement Palms	Disposition
	Species	Ht.	CT		Condition	•	Disposition
#	Species Botanical Name / Common Name	Ht. (Feet)	CT (Feet)	(Inches)		Palms	
# 3	Species Botanical Name / Common Name Hyophorbe lagenicaulis / Bottle Palm	Ht. (Feet)	CT (Feet)	(Inches)	Fair	Palms 0	Remove
# 3 4	Species Botanical Name / Common Name Hyophorbe lagenicaulis / Bottle Palm Hyophorbe lagenicaulis / Bottle Palm	Ht. (Feet) 5 5	CT (Feet)	(Inches) 10 10	Fair Fair	Palms 0 0	Remove Remove
# 3 4 6	Species Botanical Name / Common Name Hyophorbe lagenicaulis / Bottle Palm Hyophorbe lagenicaulis / Bottle Palm Cocos nucifera / Coconut Palm	Ht. (Feet) 5 5 15	CT (Feet) 1 1 6	(Inches) 10 10 10	Fair Fair Good-Fair	Palms 0 0 0	Remove Remove
# 3 4 6 9	Species Botanical Name / Common Name Hyophorbe lagenicaulis / Bottle Palm Hyophorbe lagenicaulis / Bottle Palm Cocos nucifera / Coconut Palm Sabal palmetto / Cabbage Palm	Ht. (Feet) 5 5 15	CT (Feet) 1 1 6 10	(Inches) 10 10 10 10	Fair Fair Good-Fair Poor	Palms 0 0 0 1	Remove Remove Remove

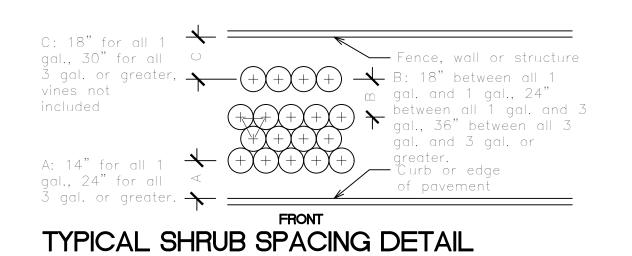




located and marked.

Check positive response codes before you dig!



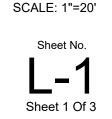

CHECKED: TW

5-19-2023

DATE:


THOMAS WHITE, ASLA—ISA

LANDSCAPE ARCHITECT, LEED

ASSOCIATE, CERTIFIED ARBOF

tcawhite@bellsouth.net

Tree Survey / Landscape Notes & Details
Fillmore Street Apartme

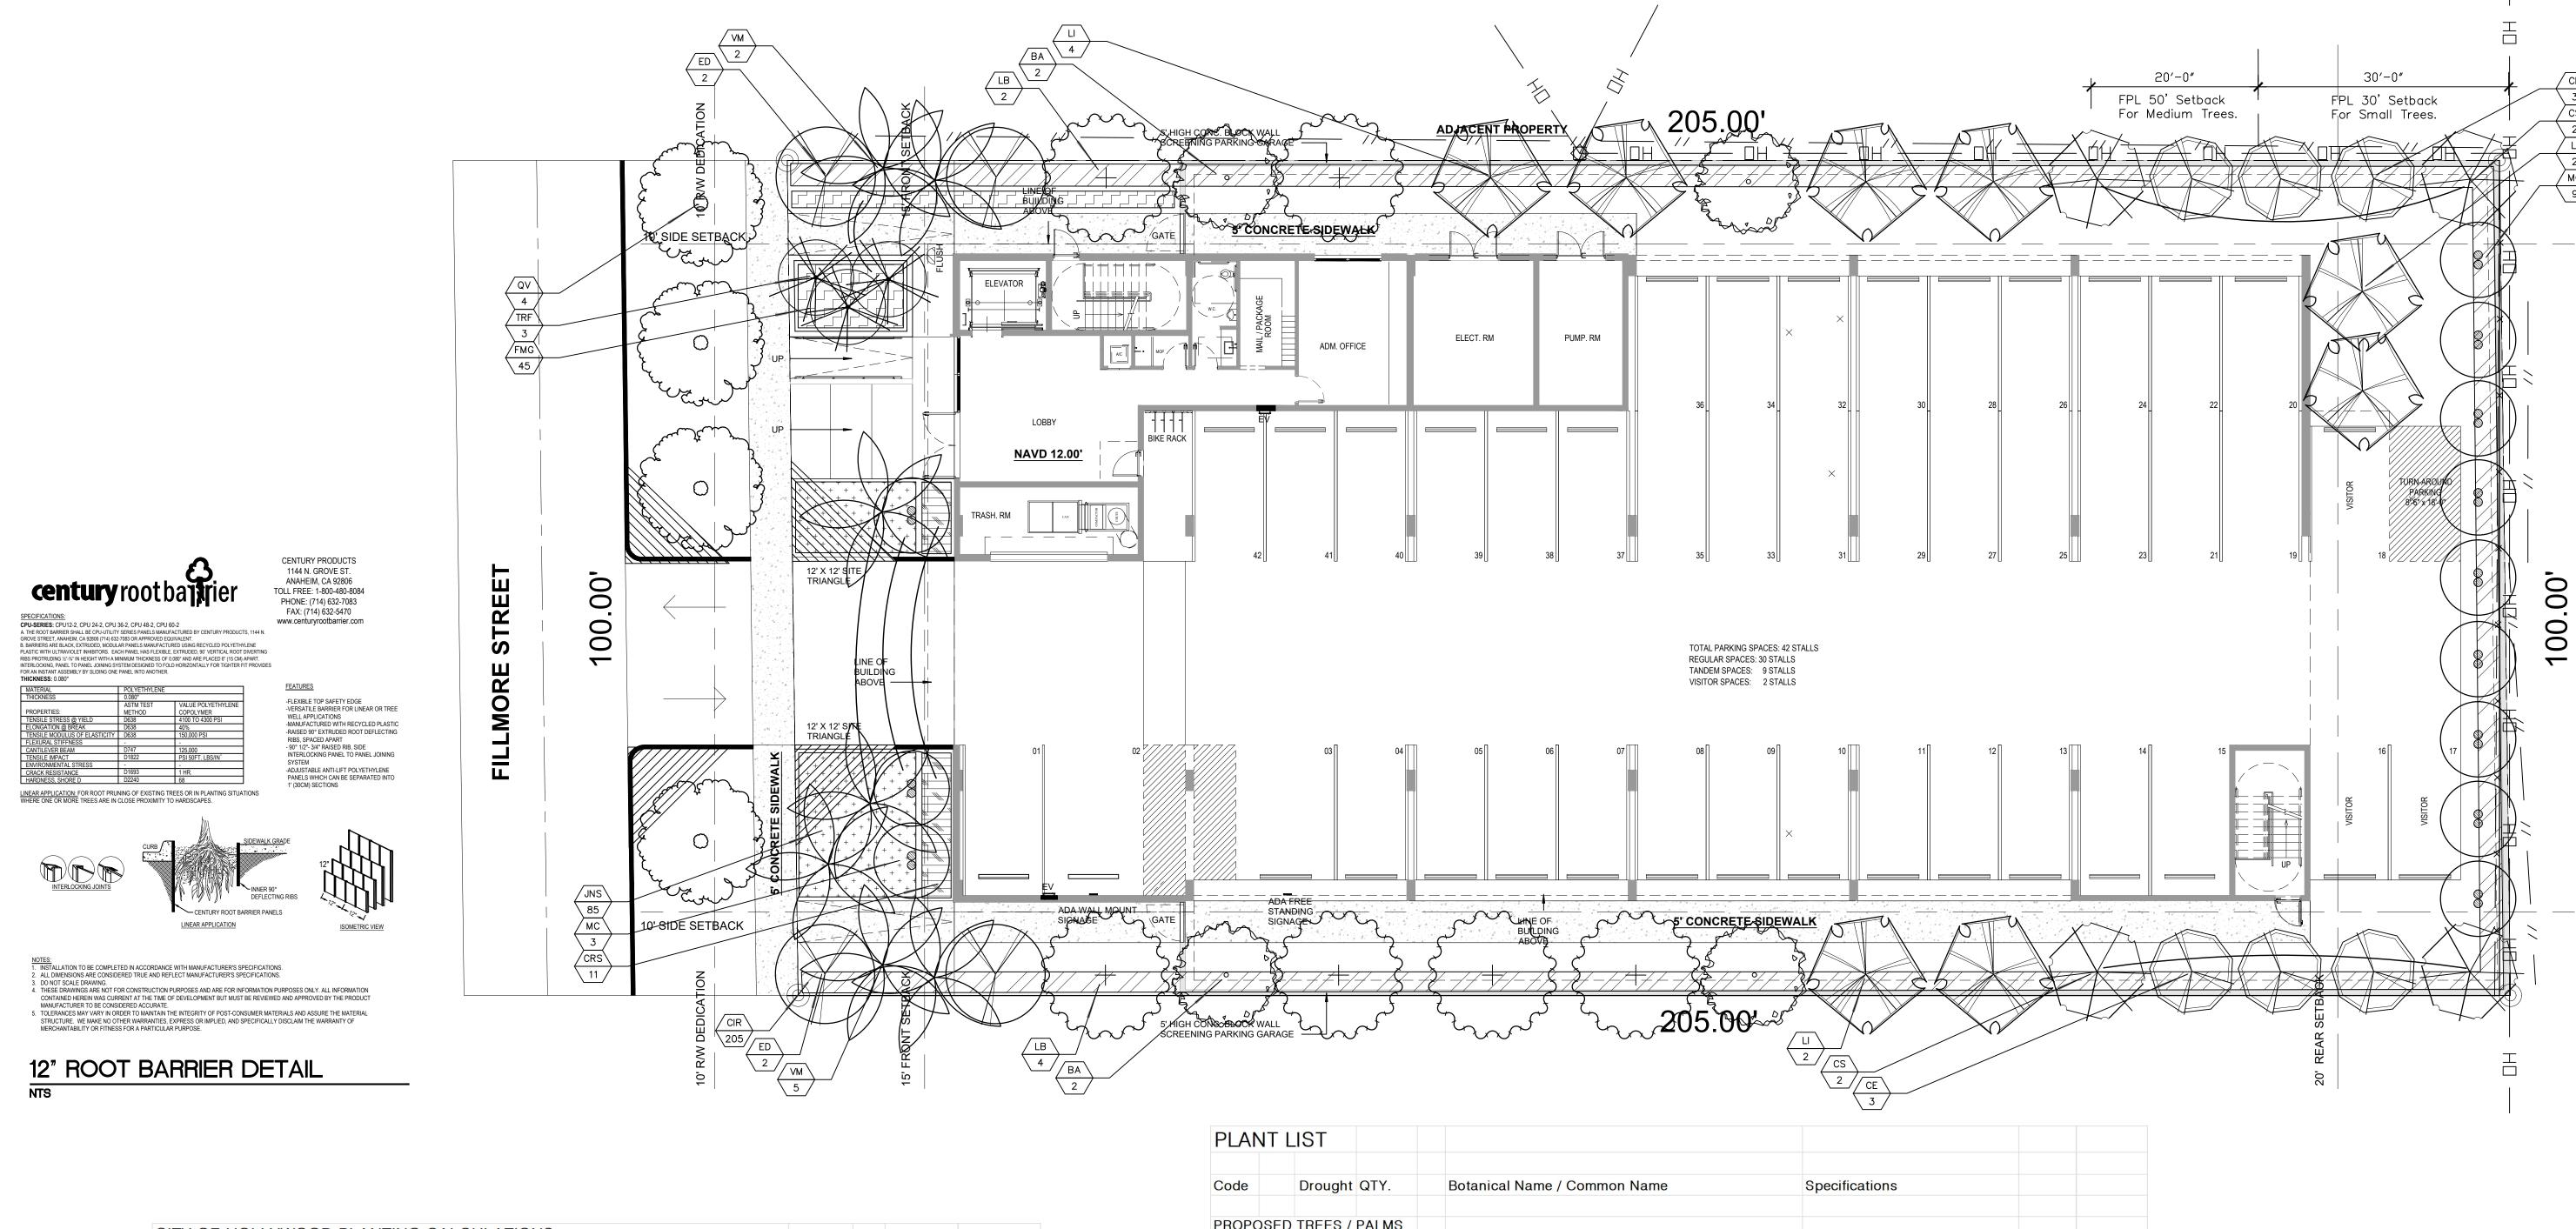

	. IOLLI		PLANTING CALCULATIONS				
4.6 RAC							
4.d.(3)1	Street T	rees: One	Per 30 LF of Street Frontage	Required		Provided	
		100 LF	Feet of Fill'more Street	4		4	
4.d.(3)2	5' Land	scape Buff	fer Required and Provided. One Tree per 20 LF				
		510 LF	Perimeter of East, North and West Boundaries	26		26	
4.d.(3)5	5' Land:	scape Buff	fer Required and Provided. 42" Landscape Element				
		510 LF	Perimeter of East, North and West Boundaries	42" Hedge		42" Hedge	CIR 42"
							See Plant List
4.d.(3)9	One Tre	e per evei	ry 1,000 square feet of Pervious Area				
		5,164	Square Feet of Pervious (Net Lot) Area.	6		6	
4.d.(3)12	20% La	ndscape C	Open Space	4,100	20%	5,164	25%
	Total Tr	ees		36		36	

CITY OF HOLLYWOO	D				
SITE PLAN INFORMATION-GR	OUND FLOO	R			
	Property Use:	RAC Single	Family F	Residential	
Pr	operty Zoning:	DH-2			
Gross Site Area:	20,502	Sq. Feet	=	0.47	Acres
Building Footprint Area:	12,585	Sq. Feet	-	61.4%	
Driveway/Walks:	1,775	Sq. Feet	=	8.7%	
VUA Exterior:	978	Sq. Feet		4.8%	
Total Impervious Areas:	15,338	Sq. Feet		74.8%	
Landscape Area:	5,164	Sq. Feet	=	25.2%	
Total Pervious Areas:	5,164	Sq. Feet			

PLAN							
Code		Drought	QTY.	Botanical Name / Common Name	Specifications		
PROPO	SED	TREES /	PALMS				
CE	(N)	V	6	Conocarpus erectus sericeus / Silver Buttonwood	12'x4-5', 2" DBH, Sng. Trunk		
CS	(N)	V	4	Cordia sebestena / Orange Geiger	12'x4-5', 2" DBH, Sng. Trunk		
ED	(1.4)	V	4	Elaeocarpus decipiens / Japanese Blueberry	12'x4-5', 2" DBH, Sng. Trunk		
LB	(N)	V	6	Lysiloma bahamensis / Wild Tamarind	12'x4-5', 2" DBH, Sng. Trunk		
LI	()	V	6	Lagerstroemia indica 'Natchez' / Crape Myrtle, Watermelon Red	12'x4-5', 3" DBH, Sng. Trunk		
MC	(N)	V	4	Myrica cerifera / Wax Myrtle	12'x4-5', 3" DBH, Sng. Trunk		
QV	(N)	V	4	Quercus virginiana / Live Oak	12'x4-5', 2" DBH, Sng. Trunk		
VM	(1.4)	V	6	Veitchia montgomeryana / Montgomery Palm	8' CT Min.		
			36	Total Trees/Palms (VM Counted 3:1)			
			24	Native Trees			
			67%	Native Trees			
			07%	Native frees			
MITIG/	ATION	TREE/P/	ALM LIST				
Code		Drought		Botanical Name / Common Name	Specifications	DBH	Total
						(Inches)	(Inches)
BA		V	4	Bulnesia arborea / Verawood	12' Ht., 4" DBH, Sng. Trunk	4	16
LI		V	2	Lagerstroemia indica 'Natchez' / Crape Myrtle, Watermelon Red	12' Ht., 3" DBH, Sng. Trunk	3	6
MC	(N)	V	8	Myrica cerifera / Wax Myrtle	12'x4-5', 3" DBH, Sng. Trunk	3	24
VM		V	1	Veitchia montgomeryana / Montgomery Palm	8' CT Min.		
					Total DBH Added		46
					Total DBH Removed		65
					DBH Deficiency		19
				Payment In	to the Tree Trust Fund @ \$350 per ea. 2" =		\$3,325
					Total Palms Added		1
					Total Palms Removed		1
					Palms Deficiency		0
HEDGE	-	HRUBS					
CIR	(N)	V	205	Chrysobalanus icaco 'Red Tip' / Cocoplum	7 Gal., 42-48"x 24-30", 30" OC		
CRS	(N)	V	11	Clusia rosea / Small Leaf Clusia	7 Gal., 48"x 24", 36" OC		
TRF	(N)	V	3	Thrinax radiata / Florida Thatch Palm	6-7' OA Ht., Dbl. Trunks		
	(14)		219	Total Shrubs	o / G/(Tit., DD). Hallio		
			219	Native Shrubs			
			100%	Native Shrubs			
GROUI	ND CC	OVERS / S					
FMG		V	45	Ficus microcarpa / Green Island Ficus	3 Gal., 18" Spr., 18-20" OC		
JNS		V	86	Jasminum nitidum / Shining Jasmine	3 Gal., 18"x 18", 24" OC		
Sod		M		S.F. Stenotaphrum secundatum / St. Augustine 'Palmetto'	Solid application - no gaps between seams		

Sunshine [1]

Call 811 or www.sunshine811.com two full business days before digging to have utilities located and marked.

Check positive response codes before you dig!



REVISIONS

partments

CHECKED: TW DATE: 5-19-2023

SCALE: 1"=10'

00.00

1)IRRIGATION CONTROLLER

(5) WIRELESS RAIN SENSOR

Sunshine

Call 811 or www.sunshine811.com two full

business days before digging to have utilities located and marked.

Check positive response codes before you dig!

13" (33 CM) OPEN DOOR WIDTH

FRONT ELEVATION

IRRIGATION CONTROLLER and RAIN CLIK SENSOR

(2) IRRIGATION CONTROL WIRE IN CONDUIT


SIZE AND TYPE PER LOCAL CODES


3 ELECTRICAL SUPPLY CONDUIT CONNECT TO POWER SOURCE, J-BOX INSIDE CONTROLLER


(4) ADJACENT SURFACE TO MOUNT CONTROLLER PER PLAN

NOTE
MOUNT CONTROLLER LCD SCREEN AT EYE LEVEL, CONTROLLER
TO COOCHUDED 140 MAC POWER SOURCE

SHALL BE HARD-WIRED TO GROUNDED 110 VAC POWER SOURCE

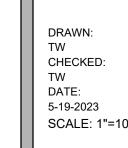

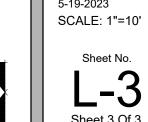

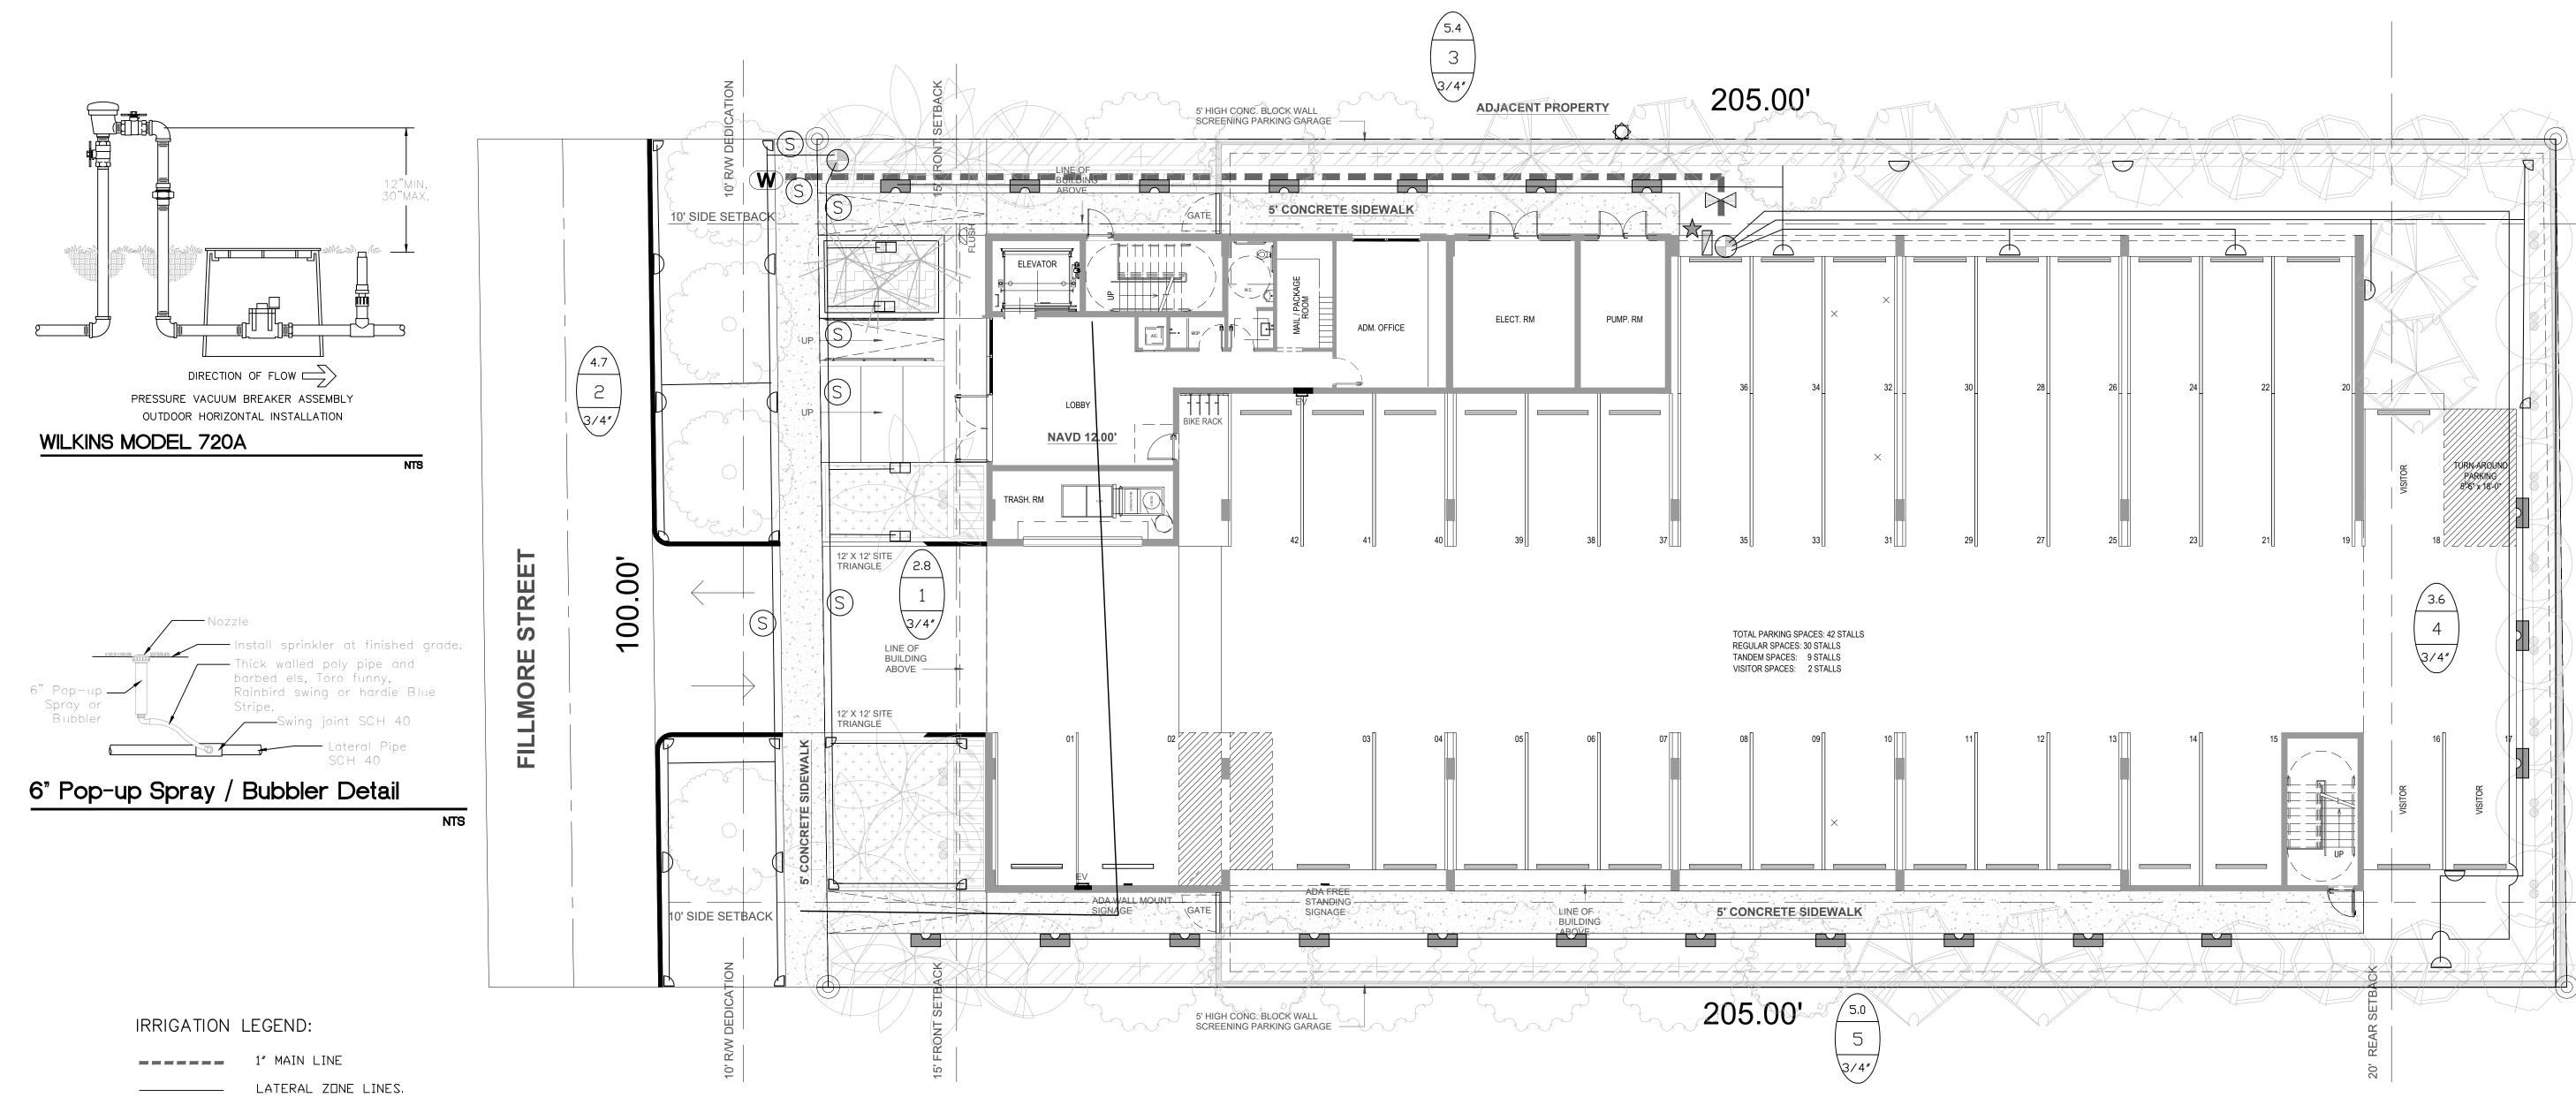

CONTROLLER - Intermatic Electric 8 station

controller wall mounted outside. Mini Clik automatic rain sensor shutoff switch mounted outside on eave of structure.

ZONE VALVES - Fimco 4 Station Indexing.

W 1" WATER METER & BACKFL□W (See Civil Plans).


6" P□P-UP SPRAY -

SLEEVES -Sch. 40, 2 Sizes Larger. NOTE - Pipe Size Shown is the Lateral Size, NOT the Sleeve Size

> Hunter Pro-Spray Series: Fixed or Adjustable Arc Nozzles as Required. NOTE - All of the below may not be used 13-21′ 8-15′ 6-12′ Series Series 90 Q 120 T 180 H 240 TT 270 TQ Ð Ð

□ SS-530 5 × 30′

360 F

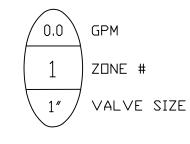

IRRIGATION NOTES:

Main Lines: PVC SCH 40 Solvent Weld. All pipe is 3/4 inch. Sleeves and suction Line: PVC SCH 40.

Fabrication: To manufacturers specifications. Use blue or grey

All pipe, fittings, and solvents to conform to latest ASTM specs.

Sleeving under pavement = 24 in. depth, min. Suction Line = 24 in. depth, nominal.

Control Wires: AWG 14 for all hot wires and AWG 12 for common. Solid copper type UF UL listed for direct burial.

> Run spares, two min. Splice wires only in a valve box. All splices shall be moisture proof using Snap tite or DBY UL connectors.

Backfill all trenches free of debris, compact to original density, flush all lines, use screens in all heads, adjust heads for proper coverage avoiding excess water on walls, walks, etc.

All details are graphically shown only. All quantities shall be verified by the contractor prior to installation. It shall be the contractors responsibility to assure complete overlapping coverage. Any discrepancies shall be reported to the owner and landscape architect before proceeding. Codes and local regulations shall take precedence over these plans, it is the contractors responsibility to comply. The landscape architect reserves the right to make minor field changes, the contractor may field adjust spray nozzle selection to provide for proper 100% min, coverage,

valves, crossings, etc. using dimensions from fixed datums.

Zone Lines: PVC SCH 40 Solvent Weld. 1/2 in. is not used.

Fittings: SCH 40 PVC

PVC cement, square cut, clean and prime all joints.

Allow all main lines to cure for 24 hours before pressuring.

Depth of Lines: Main Line and wiring = 18 in. depth, min. Zone Lines 1-1/2 in. and smaller = 10 in. depth, min.

Run wires under main.

Common shall be white, hot shall be red or color coded Spare shall be black. Run all wires in Grey Electrical SCH 40 conduit...

Provide owner with an accurate as installed plan(s) at completion showing main lines, wiring,

Contractor shall verify all underground utilities prior to commencement of work.